

Client: Belmore Car Wash

Document Type: Section 4.55 Modification Report

Document Title: Modification to DA/538/2019 | 607 Canterbury Road, Belmore

Version: Final

Issue Date: 17 March 2022

Prepared By: Guy Evans | Director

If this document is not signed it is a draft.



© Urbanco Group Pty Ltd | ABN 56 616 790 302 | urbanco.com.au Suite 3.03 55 Miller Street PYRMONT NSW 2009 | PO Box 546 PYRMONT NSW 2009 | 02 9051 9333

This work is copyright. Apart from any use permitted under the Copyright Act 1968, no part may be reproduced by any process, nor may any other exclusive right be exercised, without the permission of Urbanco Group Pty Ltd.

CONTENTS

1 Introduction			1	
2	Site & Context			
	2.1	Land Details	2	
	2.2	Site Description	2	
3	Proposal			
	3.1	Proposed Modifications	3	
	3.1.1	Car Wash Bay Structure	3	
	3.1.2	Amendment to Landscape Plan	3	
	3.1.3	Stormwater Design	3	
	3.2	Proposed Modifications to Conditions	3	
4	Section	on 4.15 – Evaluation	5	
	4.1	Clause (1) Matters for consideration—general	5	
	4.1.1	Provisions of Environmental Instruments	5	
	4.1.2	Provisions of any Draft Environmental Planning Instruments	6	
	4.1.3	Provisions of any Development Control Plan	6	
5	Section	on 4.46 – Integrated Development	7	
6	Section	on 4.55 – Modification of ConsentsGenerally	8	
7	Conc	lusion	9	



Appendices

Appendix 1 Proposed Modified Architectural Plans
 Appendix 2 Proposed Modified Landscape Plan
 Appendix 3 Proposed Modified Stormwater Design
 Appendix 4 Fire Safety Compliance

Figures

Figure 1 Land Details

Tables

Table 1 Land Details
 Table 2 Table 2: Proposed Modification to Conditions
 Table 3 LEP Assessment
 Table 4 Integrated Development Assessment
 Table 5 Response to Criteria under Section 4.55(1A)



1 INTRODUCTION

On behalf of Belmore Car Wash, approval to modify the consent for DA/538/2019 at 607 Canterbury Road, Belmore in accordance with Section 4.55(1A) of the *Environmental Planning and Assessment Act 1979* is sought.

DA/538/2019 approved the demolition of existing unauthorised car wash structures and installation of a new car wash including associated structures, noise barriers, queuing, parking and waiting areas.

This modification proposal seeks minor changes to the cash wash structure to amend the shape of the roof structure and remove an internal wall. The modification proposal also seeks to amend the landscaping, stormwater design and delete a condition of consent relating to Category 1 fire safety requirements as necessary compliance requirements are already achieved.

The site is zoned B5 Business Development under the Canterbury Local Environmental Plan 2012.

The Canterbury Development Control Plan 2012 contains controls to guide the development of land within Belmore.

No Integrated Development referrals of the Section 4.55 application is required.

The proposed modifications do not cause any significant environmental impacts and do not result in any additional non-compliances. Accordingly, the proposed modifications are submitted under Section 4.55(1A).

Proposed architectural plans illustrating the height increase and additional structures are included in the appendices of this report.



2 SITE & CONTEXT

2.1 Land Details

The overall site has a single landowner and the current land details are in Table 1.

Table 1: Land Details

Land Details	Address
Lot B DP306677	607 Canterbury Road, Belmore
Lot 22 DP3206	607 Canterbury Road, Belmore
Lot 23 DP3206	607 Canterbury Road, Belmore
Lot 24 DP3206	607 Canterbury Road, Belmore
Lot 25 DP3206	607 Canterbury Road, Belmore



Figure 1 – Land Details (Source: SIX Maps)

2.2 Site Description

The site fronts Canterbury Road to the southeast and a laneway to the northwest. There are vehicle repair and parts business either side of the site. There are also vehicle repair businesses on the opposite side of Canterbury Road as well as residential dwellings.

The site contains an existing service station, offices, convenience store, car wash and mechanical repair workshop with parking and associated structures and signage. The site slopes downwards towards the laneway and comprises two (2) levels. The service station, offices, convenience store, car wash and some parking are at grade with Canterbury Road, where there is also an entry and egress to the Classified Road. There is a concrete wall that forms the northern boundary around the service station and car wash.



3 PROPOSAL

The proposed modifications to DA/538/2019 include a minor change to the cash wash structure to change the shape of the roof structure and remove an internal wall. The modification proposal also seeks to amend the landscaping, stormwater design and delete a condition of consent relating to Category 1 fire safety requirements as necessary compliance requirements are already achieved.

The Modification Proposal is of minimal environmental impact. The proposed modification does not:

- 1. cause any significant environmental impacts and do not result in any non-compliances.
- 2. impose any additional impact that would concern any of the referral authorities consulted as part of the initial development application.

3.1 Proposed Modifications

3.1.1 Car Wash Bay Structure

It is proposed to adopt minor modifications to the car way bay structure. The roof shape of the car wash bay structure is to change from a curved roof shape to a pitched roof shape with a gentle roof pitch to allow rainwater to flow away from the roof.

In is also proposed to remove a central wall within the car wash structure.

The modifications are minor and will not significantly change the appearance or function of the car wash, and areas subject to modification are highlighted in Architectural Plans in Appendix 1.

3.1.2 Amendment to Landscape Plan

The Development Consent approved a landscape strip of 1 metre in width along the frontage to Canterbury Road. A 1 metre landscaping strip does not provide adequate width between the petrol bousers for vehicles. It is proposed to reduce the width of the landscaping strip to 0.6 metres.

The Development Consent approved deep soil zones adjacent to western boundary are constrained due to shallow depth to fuel storage tanks. It is proposed to remove landscaping from this location or require above ground planter boxes.

The amendments to the landscape design are highlighted in the modification Landscape Plan in Appendix 2.

3.1.3 Stormwater Design

The Construction Certificate stormwater design was defective and a revised stormwater design that adopts the correct area calculations relating to the new structure is required to be adopted. The amendment stormwater concept is in Appendix 3.

3.2 Proposed Modifications to Conditions

The modification proposal seeks to modify the Development Consent by amending the conditions as shown in Table 2.

Table 2: Proposed Modification to Conditions

Proposed Modification	Explanation		
Conditions of Consent			
4) The building must comply with the Category 1 fire safety provisions as are applicable to the building's proposed use.	Delete Condition "4)" as there is no amendment to existing services. Australian Consulting Engineers confirms compliance with fire safety requirements (see Appendix 4) and compliance with Category 1 requirements is not considered reasonable.		



Proposed Modification

Explanation

- 8) A landscape plan must be submitted prior to the issue of any construction certificate, which shows the following:
 - a) A 2m deep soil landscaping strip 200mm high planter of at least 1m in width being provided along the eastern boundary, adjacent to parking space no. 09, as shown in red on the approved plans. This is to be to the satisfaction of the Private Certifier.

The deep soil landscape area is too shallow and the width need to reduce to allow adequate parking space. The amended Part "a)" is consistent with the modified Landscape Plan.

b) A 4m-0.6m deep soil landscaping strip along the southern boundary adjacent to parking spaces no. 12 and 13, which runs for west to east from the right wing of the entry driveway to the left wing of the exit driveway to Canterbury Road, as shown in red on the approved plans. This is to be to the satisfaction of the Private Certifier.

Amendment to width of landscaping strip to allow adequate width for vehicles to enter and exit the fuel refilling area.

c) The existing area of landscaping on the western boundary, adjacent to parking space no. 01 is to be updated with new deep soil landscaping and the concrete must be removed.

The deep soil landscape area is too shallow due to existing fuel storage tanks. Part "c)" to be deleted or replaced with requirement for above ground planter boxes.



4 SECTION 4.15 – EVALUATION

Clause 4.15 of the Environmental Planning & Assessment Act 1979 outlines the matters to be considered in evaluating a development proposal, which are detailed in Clause 1.

4.1 Clause (1) Matters for consideration—general

4.1.1 **Provisions of Environmental Instruments**

Canterbury Local Environmental Plan 2012


Canterbury Local Environmental Plan 2012 is the principal Environmental Planning Instrument for the site.

Table 3: Compliance with LEP

SEPP Provision Comment **B5 Zone Objectives** The application proposes a height increase to the main car wash bay structure, a pergola and a shade structure which To enable a mix of business and warehouse uses, act ancillary to an approved commercial activity within a and specialised retail premises that require a large service station that is permissible within the B5 zone. This floor area, in locations that are close to, and that type of use supports and encourages other commercial support the viability of, centres. activities in the locality. To provide for residential use in conjunction with The proposal meets the B5 zone objectives. mixed use development to create an attractive streetscape supported by buildings with a high standard of design. To support urban renewal that encourages an increased use of public transport, walking and To encourage employment opportunities on Canterbury Road and in accessible locations.

Clause 2.1 Land Use Zones

The site is zoned 'B5 Business Development'.

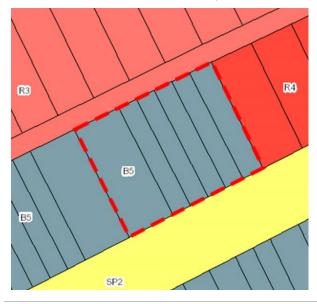

Given the proposed wash bay roof structure increase, pergola structure and shade sail are ancillary to the approved commercial development on site, the proposal complies with the zone requirements.

The proposal is consistent with the B5 zone provisions.

Clause 4.3 - Height of Buildings

Height of Buildings Map identifies the site as "P" which imposes a maximum building height of 18 metres.

The proposed height increase of the Car Wash Bay structure will result in a maximum building height of 5m.

The proposed pergola structure and shade sail will be erected at a maximum height adjoining the car wash bay roof of 3.69m.

The proposal complies with the maximum allowable building height.



State Environmental Planning Policy (Infrastructure) 2007

Clauses 101 and 104 of the Infrastructure SEPP apply to this proposal which relate to developments fronting a classified road and traffic generating development respectively. Clause 101 reads:

101 Development with frontage to classified road

- (1) The objectives of this clause are:
 - (a) to ensure that new development does not compromise the effective and ongoing operation and function of classified roads, and
 - (b) to prevent or reduce the potential impact of traffic noise and vehicle emission on development adjacent to classified roads.
- (2) The consent authority must not grant consent to development on land that has a frontage to a classified road unless it is satisfied that:
 - (a) where practicable and safe, vehicular access to the land is provided by a road other than the classified road, and
 - (b) the safety, efficiency and ongoing operation of the classified road will not be adversely affected by the development as a result of:
 - (i) the design of the vehicular access to the land, or
 - (ii) the emission of smoke or dust from the development, or
 - (iii) the nature, volume or frequency of vehicles using the classified road to gain access to the land, and
- (c) the development is of a type that is not sensitive to traffic noise or vehicle emissions, or is appropriately located and designed, or includes measures, to ameliorate potential traffic noise or vehicle emissions within the site of the development arising from the adjacent classified road.

The proposed car wash bay structure height increase, pergola structure and shade sail are ancillary to the approved car wash premise. As such, they will not impact traffic generation as approved under DA/538/2019. Referral to the RMS is not required.

4.1.2 Provisions of any Draft Environmental Planning Instruments

The proposal or site is not subject to any draft Environmental Planning Instruments.

4.1.3 Provisions of any Development Control Plan

The proposed modifications to DA/538/2019 have been assessed with the Canterbury DCP 2012. The proposed amendments are minor in nature and do not result in any additional non-compliances.



5 SECTION 4.46 – INTEGRATED DEVELOPMENT

An assessment of Integrated development requirements under Section 4.46 of the *Environmental Planning & Assessment Act 1979* is in Table 4.

Table 4: Integrated Development Assessment

Legislation	Referral	Comment
Fisheries Management Act 1994	No	No aquaculture permit required.
Heritage Act 1977	No	The area subject to this modification is not within a State Heritage Register List curtilage.
Biodiversity Conservation Act 2016	No	No significant ecological impacts result from the proposal.
National Parks and Wildlife Act 1974	No	No Aboriginal Cultural Heritage
Mine Subsidence Compensation Act 1961	No	Site is not within a Mine Subsidence Area.
Mining Act	No	Not subject to a mining lease.
Petroleum (On Shore) Act	No	Not subject to a lease.
Protection of the Environment Operations Act 1997	No	Environment Protection Licence not required.
Roads Act 1993	No	No works to a public road as outlined under Section 138 of the <i>Roads Act 1993</i> .
Rural Fires Act 1997	No	Part of the site is identified as bushfire prone.
Water Management Act 2000	No	No works within 40 metres of a classified stream under the <i>Water Management Act 2000</i> .

No Integrated Development referrals are required as part of this modification application.



6 SECTION 4.55 – MODIFICATION OF CONSENTS-GENERALLY

Section 4.55 of the *Environmental Planning & Assessment Act 1979* outlines provisions for three types of modifications to a development consent. The proposed modifications meet the requirements of subclause '(1A) Modifications involving minimal environmental impact'.

Table 5: Response to Criteria under Section 4.55(1A)

A consent authority may modify the consent if:		Response		
(a)	it is satisfied that the proposed modification is of minimal environmental impact.	The proposed modifications are to adopt minor amendments to the car wash structure, update landscape plans and the stormwater design.		
(b)	it is satisfied that the development to which the consent as modified relates is substantially the same development as the development for which the consent was originally granted and before that consent as originally granted was modified (if at all).	The proposed modifications will not increase environmental impacts for the site or surrounds.		
(c)	it has notified the application in accordance with: (i) the regulations, if the regulations so require, or (ii) a development control plan	The proposed modification is principally the same as the layout approved under DA/538/2019.		
(d)	it has considered any submissions made concerning the proposed modification	Not applicable		

The proposed modification is considered to be of minimal environmental impact and is therefore a modification under Section 4.55(1A).



7 CONCLUSION

Approval to modify the consent for DA/538/2019 in accordance with Section 4.55(1A) of the *Environmental Planning and Assessment Act 1979* is sought.

The proposed modification to the consent for DA/538/2019 enables the height increase of the car wash bay roof structure, construction of a pergola structure and the erection of a shade sail over preparation and vacuuming & drying bays for the approved car wash. There are no changes to the approved layout of the car wash premise.


The proposed modifications above do not:

- 1. cause any significant environmental impacts and do not result in any non-compliances.
- 2. impose any additional impact that would concern any of the referral authorities consulted as part of the initial development application.

Given the proposal meets the requirements of Section 4.55(1A) of the *Environmental Planning and Assessment Act 1979* and all relevant instruments, plans and policies, it is requested that council approve the proposed modification.



APPENDIX 1 Proposed Modified Architectural Plans

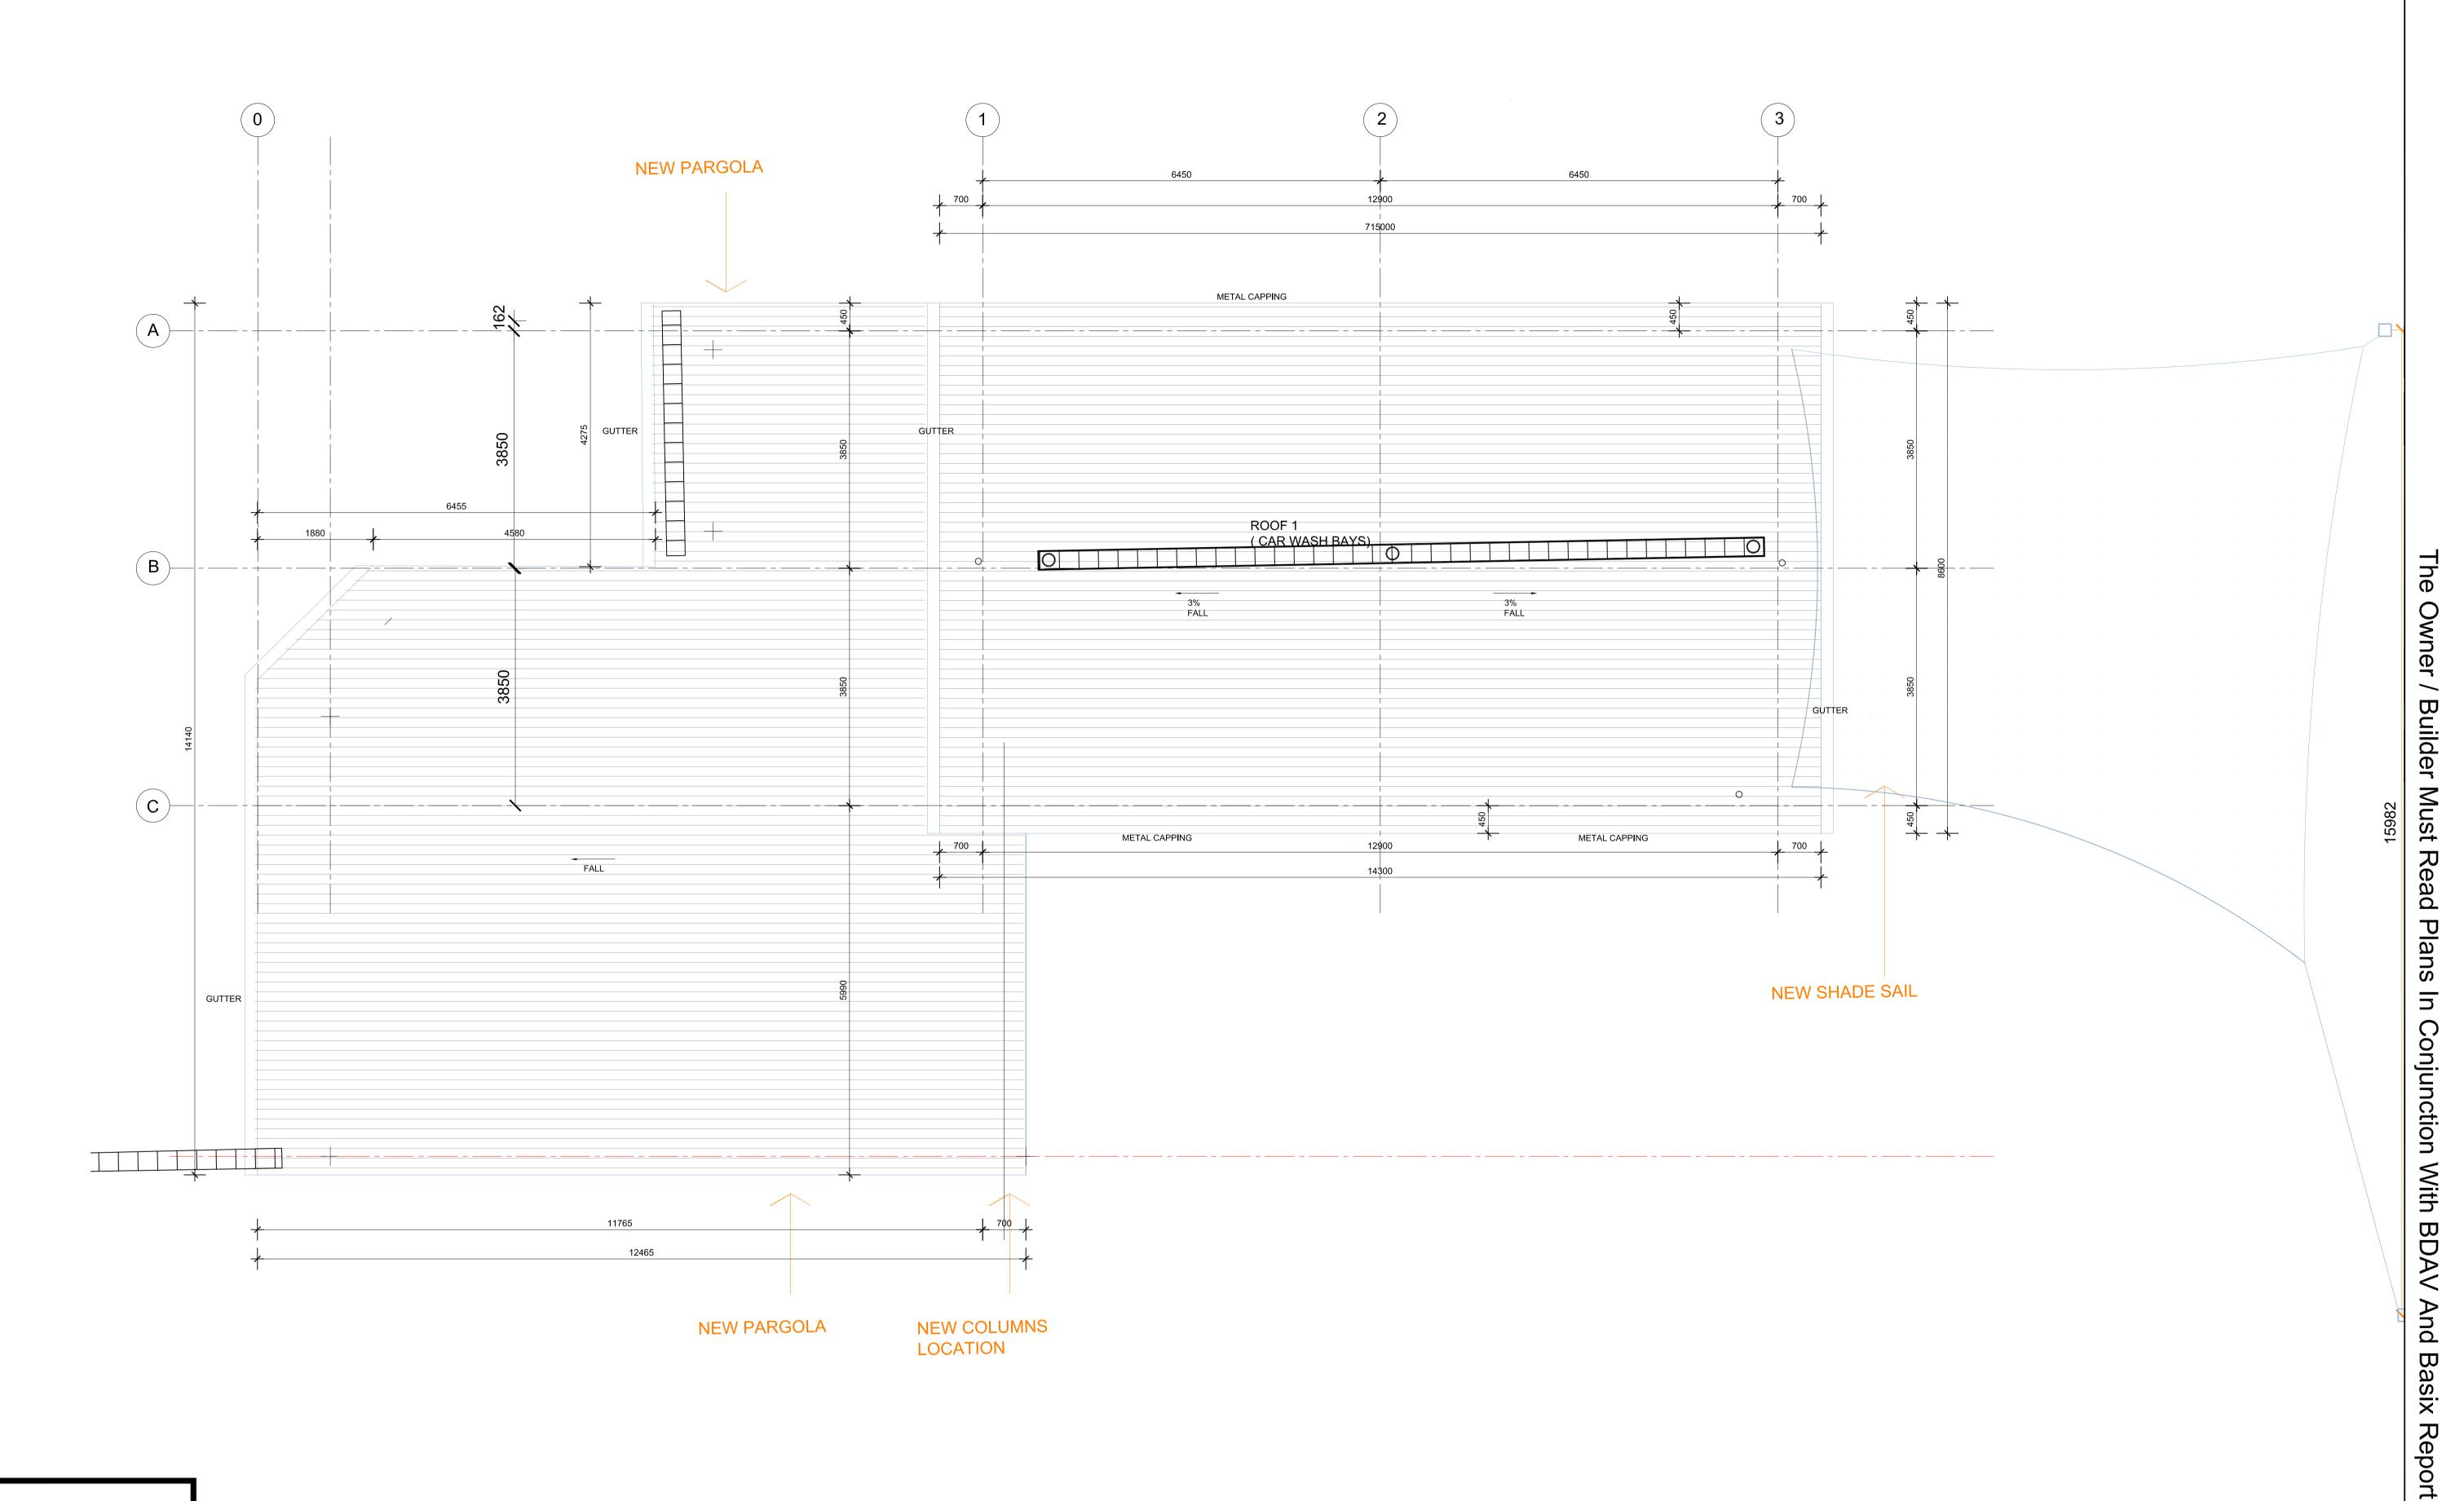



Silverwater NSW 2128 PO Box 427, Merrylands NSW 2160

Phone: 02 9648 8848

NOTE: All work to be carried out in accordance with BCA, SAA & Council's conditions.


COPYRIGHT: The concepts & information contained in these drawings are the copyright of Idraft Group Pty Ltd. Use or duplication in part or in full without written permission of Idraft Group Pty Ltd constitutes an infringement of copyright. Do not scale off architectural drawings. These notes must be read in conjunction with colours selection for additional details on appliances, PC DATE: 15.02.22 SEC4.55 ISSUE items & shower sizes shown on plan are inside hob dimensions shower screens to be fitted on inside of hob bulkheads may be required to accommodate drainage lines & steel beams position to be determined on site.

USE FIGURED DIMENSIONS ONLY, DO NOT SCALE. Finished ground levels on plans are subject to site conditions, all calculated dimensions are subject to site measure during construction & no allowance has been made for shrinkage or milling position of electrical meter to be determined on site in accordance to the correct position front garden tap on meter.

ENERGY SMART DESIGN: AAA rated water conservation devices include rainwater tanks shower heads, water taps flow regulators, dual flush toilets cisterns & compliant hot water systems with minimum green house score of 3 stars are to be used in this development. Occupants are encouraged to use AAA rated dish washing machines with front loading where possible.

DO NOT SCALE OFF ARCHITECTURAL DRAWINGS



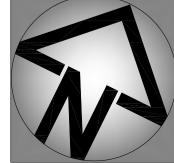



Proposed Manual Car Wash

Proposed Car Wash Roof Plan

Belmore Car Wash Pty Ltd

Local Government Area: Canterbury - Bankstown Council 607 CANTERBURY ROAD, BELMORE Drawing #: Project #: 28657

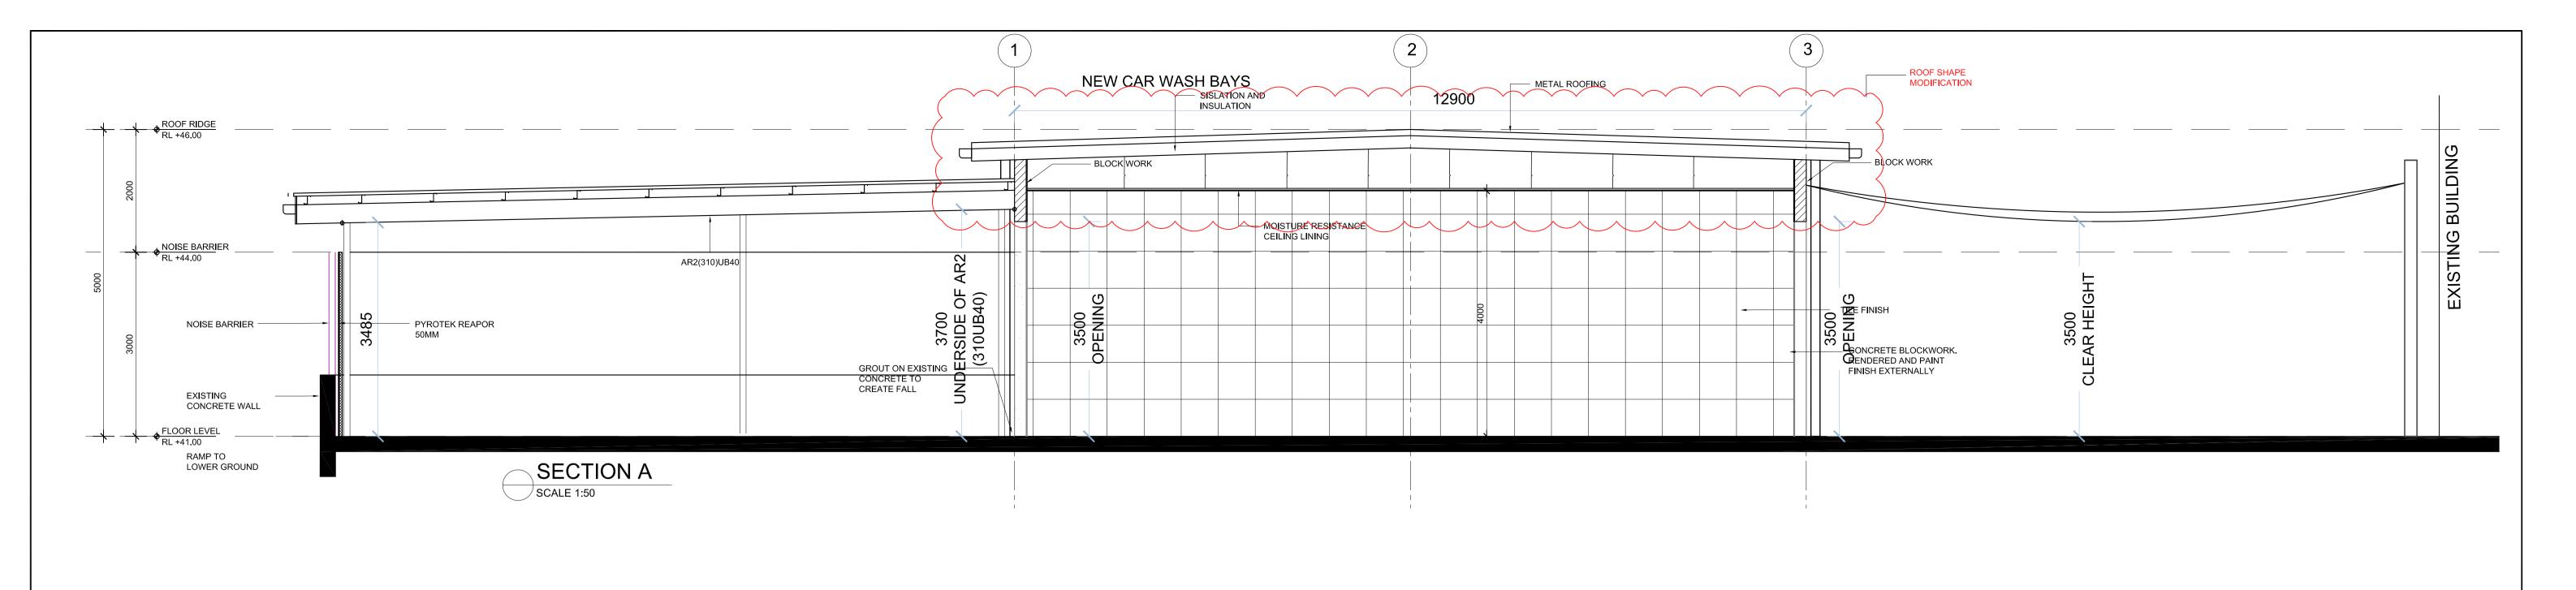

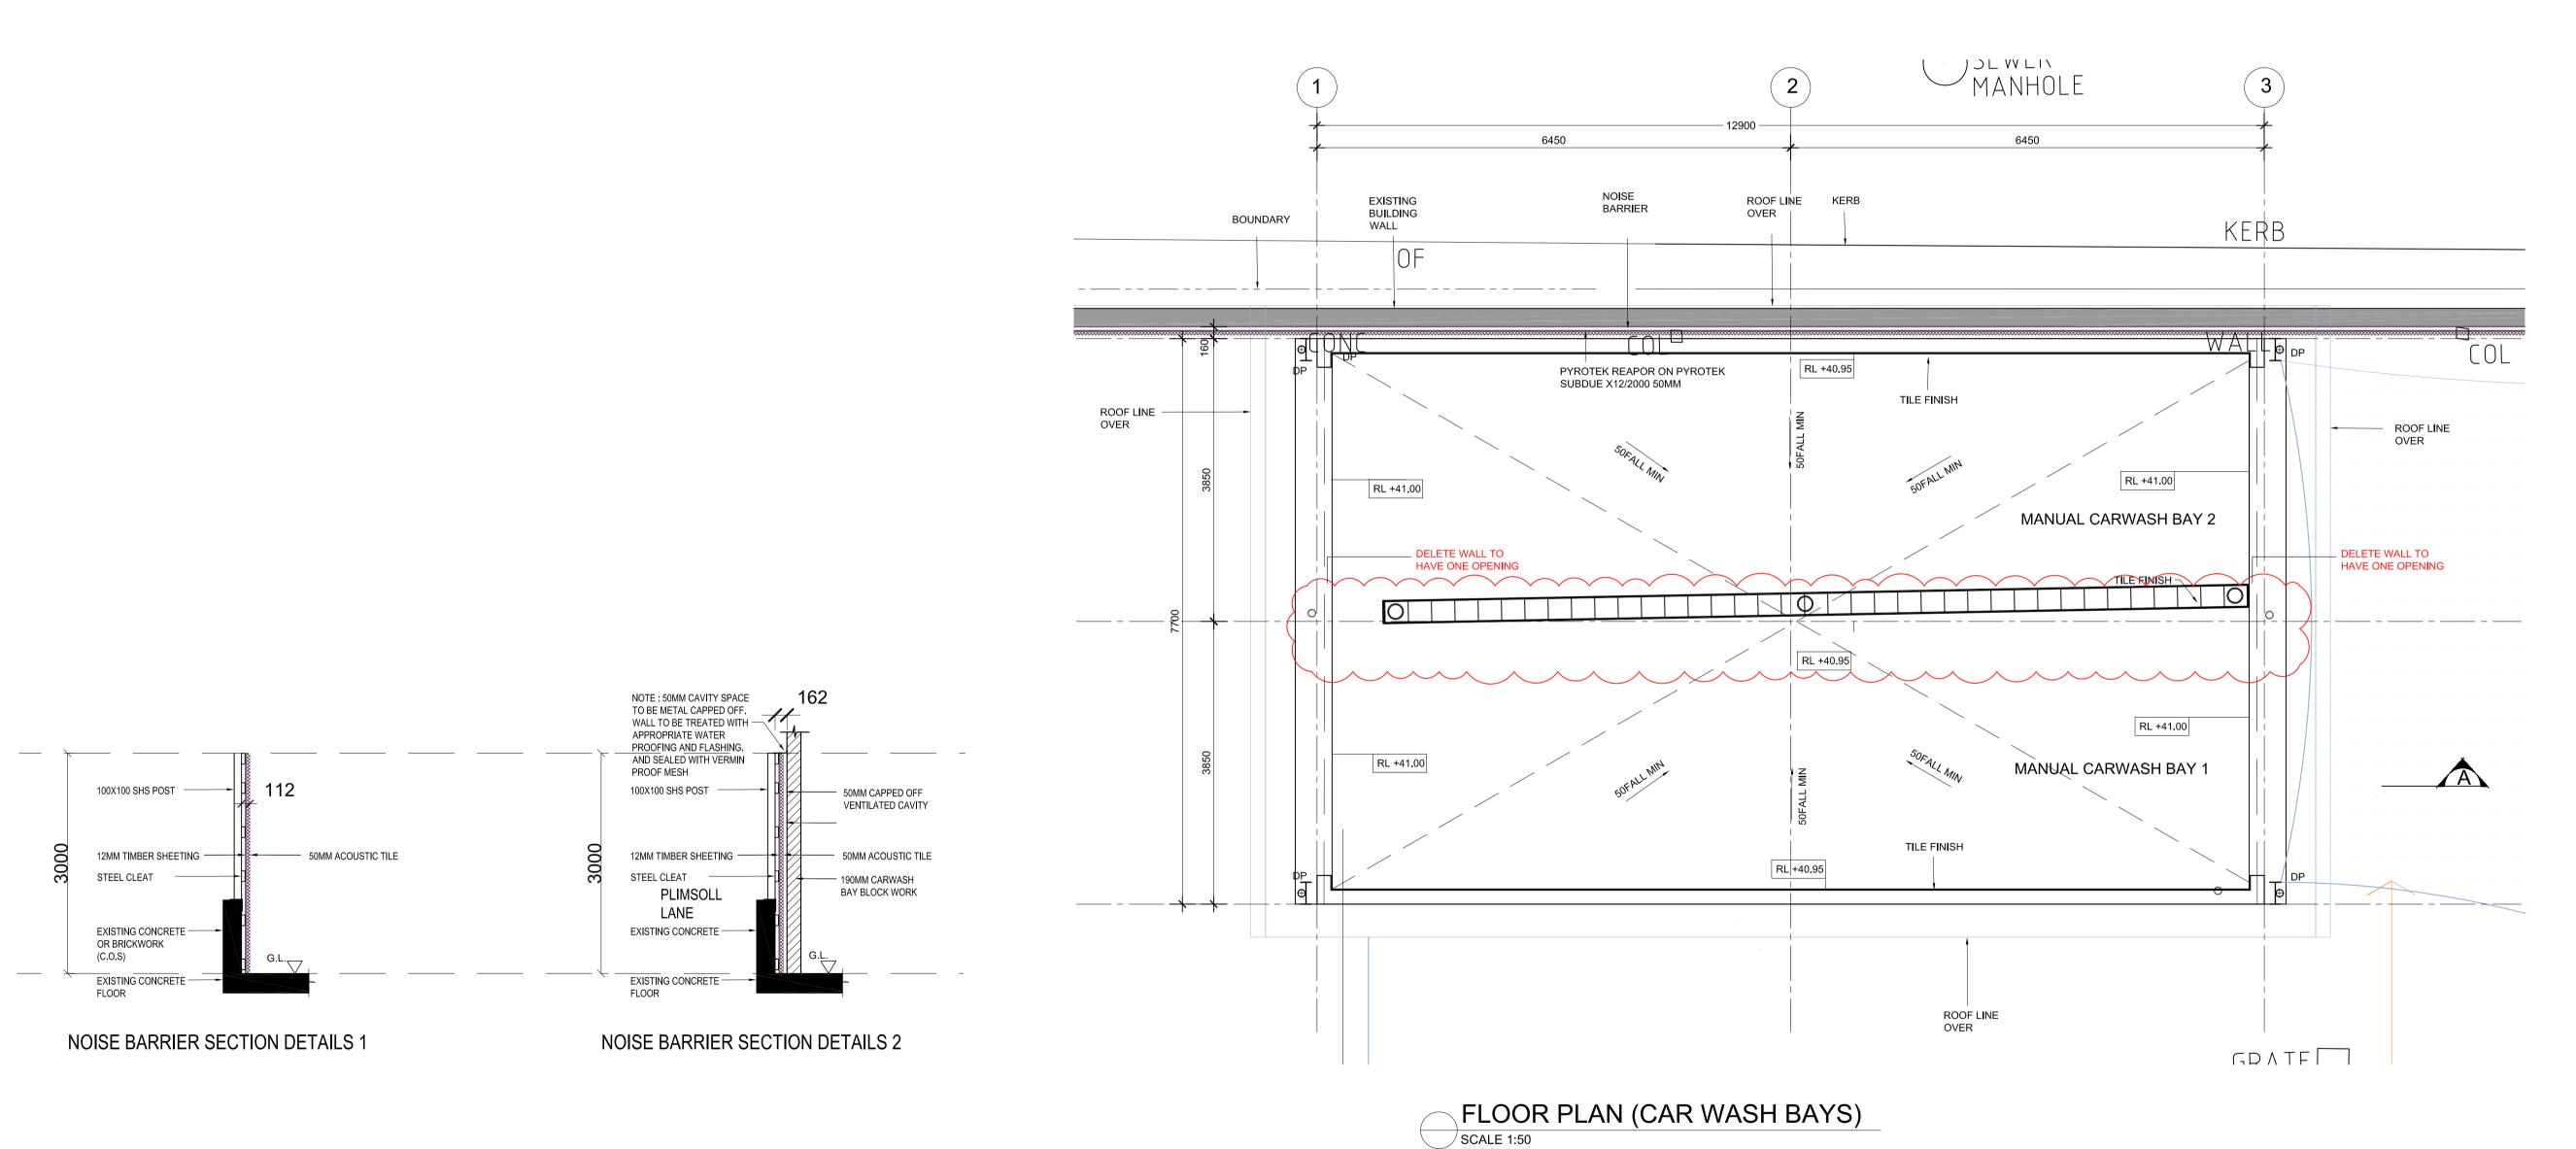


IDRAFT ARCHITECTS


NOTE: All work to be carried out in accordance with BCA, SAA & Council's conditions.

COPYRIGHT: The concepts & information contained in these drawings are the copyright of Idraft Group Pty Ltd. Use or duplication in part or in full without written permission of Idraft Group Pty Ltd constitutes an infringement of copyright. Do not scale off architectural drawings. These notes must be read in conjunction with colours selection for additional details on appliances, PC **AMENDMENTS** DATE: 15.02.22 SEC4.55 ISSUE items & shower sizes shown on plan are inside hob dimensions shower screens to be fitted on inside of hob bulkheads may be required to accommodate drainage lines & steel beams position to be determined on site. Silverwater NSW 2128 USE FIGURED DIMENSIONS ONLY, DO NOT SCALE. Finished ground levels on plans are subject to site conditions, a calculated dimensions are subject to site measure during construction & no allowance has been made for shrinkage or milling PO Box 427, Merrylands position of electrical meter to be determined on site in accordance to the correct position front garden tap on meter.

ENERGY SMART DESIGN: AAA rated water conservation devices include rainwater tanks shower heads, water taps flow NSW 2160 regulators, dual flush toilets cisterns & compliant hot water systems with minimum green house score of 3 stars are to be used in this development. Occupants are encouraged to use AAA rated dish washing machines with front loading where possible.


DO NOT SCALE OFF ARCHITECTURAL DRAWINGS Phone: 02 9648 8848 plans@idraft.com.au www.idraft.com.au

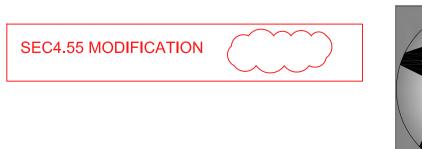


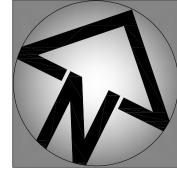

osed Manual Car Wash	Drawing Title: Proposed Car Wash Planand Section


Drawing Title:	Client Details:				
Proposed Car Wash Plans and Section	Vash Plans Belmore Car Wash Pty Ltd				
	Local Government Area: Canterbury - Bankstown Council				
Address:	Drawn: Issue For: Issue: A				
607 CANTERBURY ROAD,		roje			

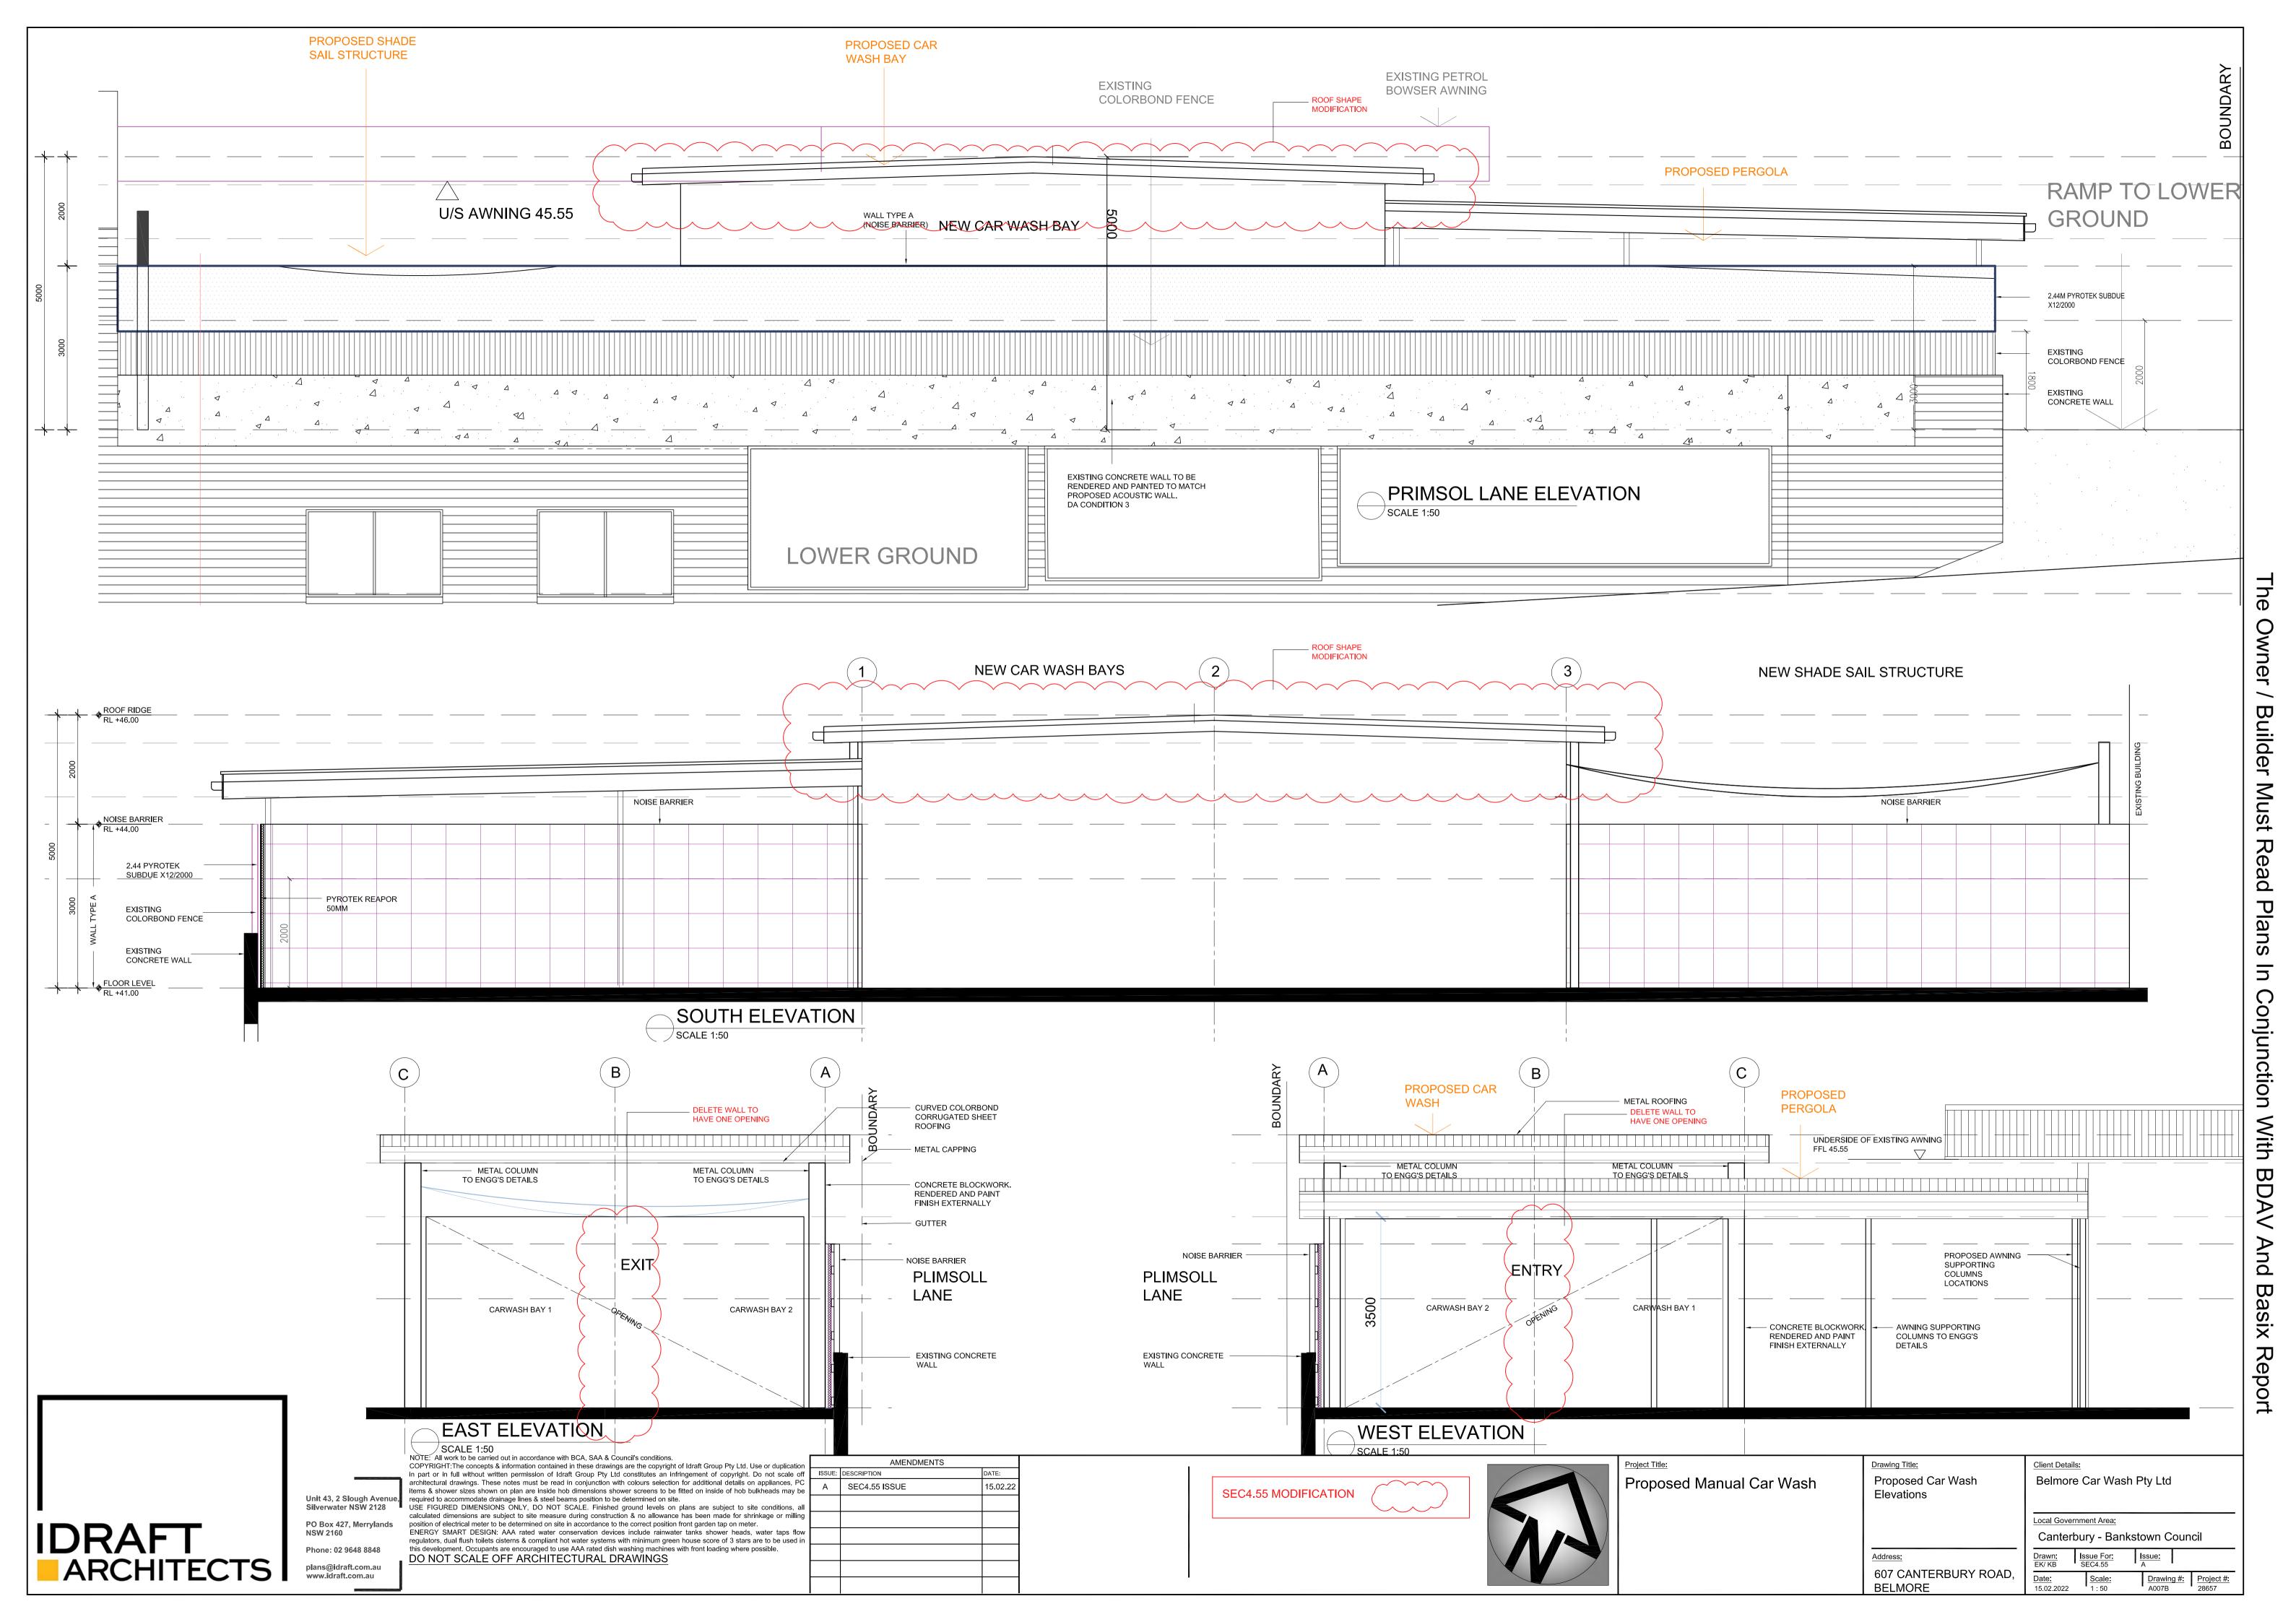


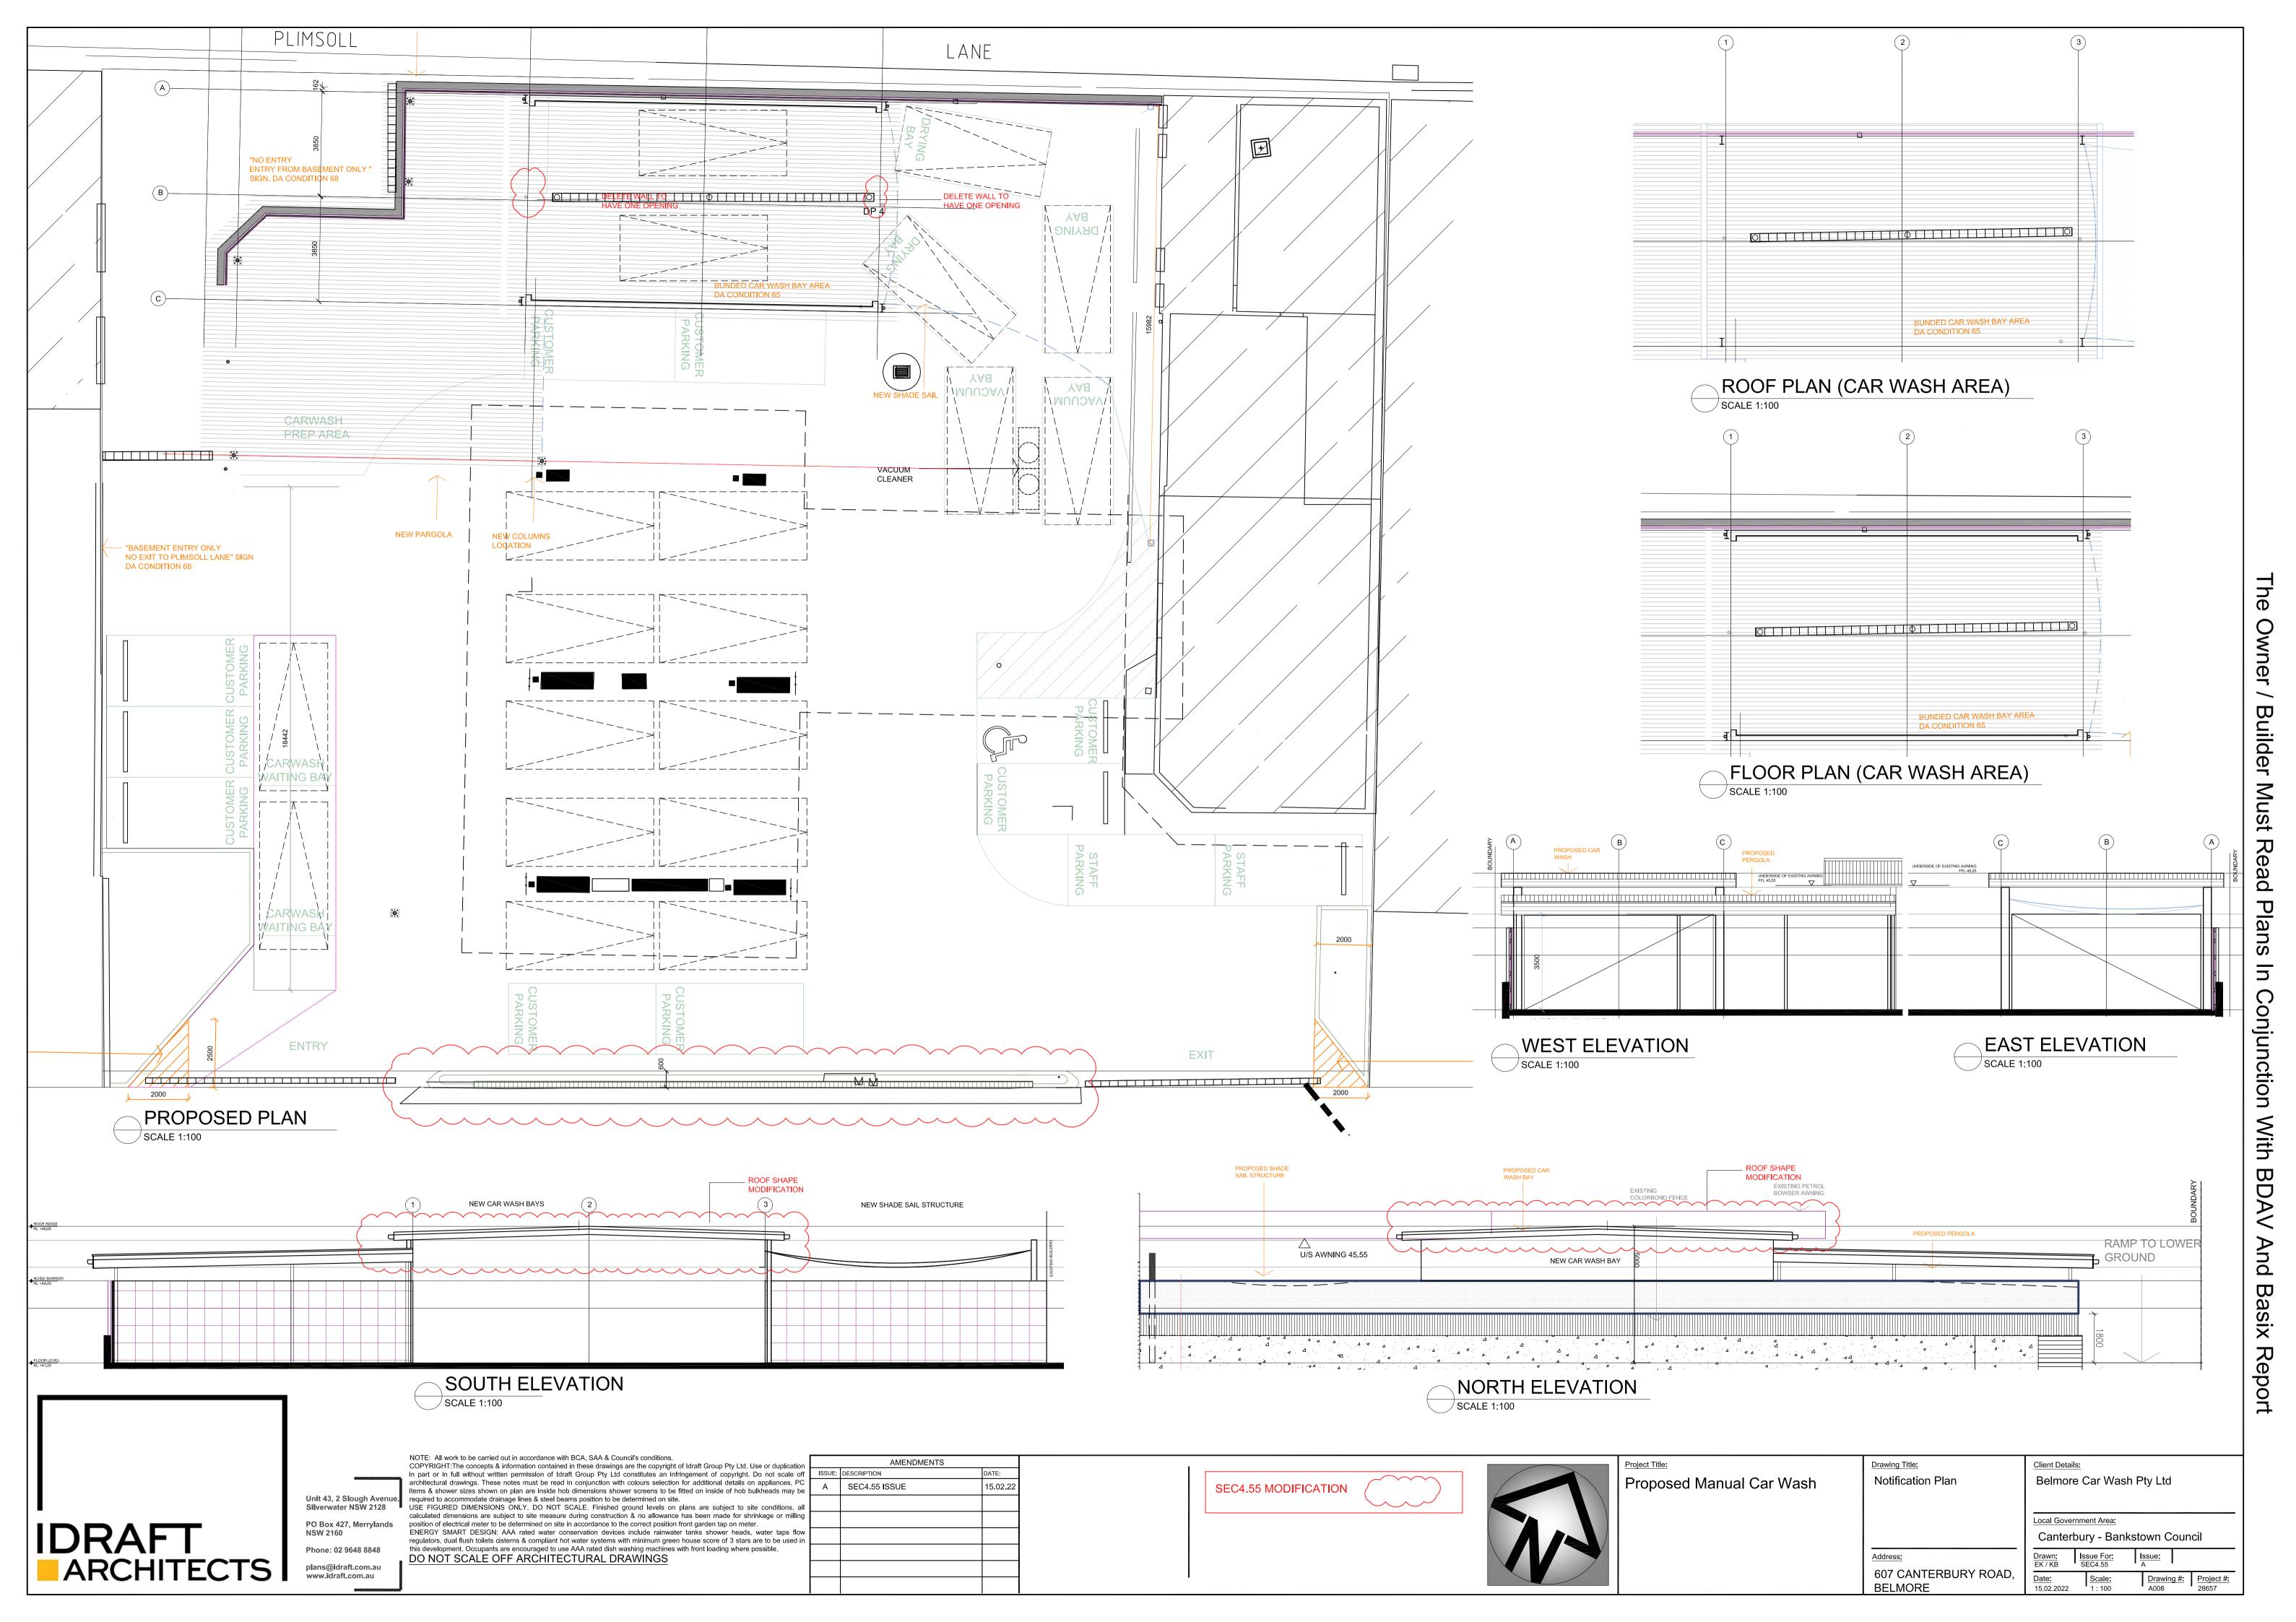




EXISTING BUILDING IMAGE 01

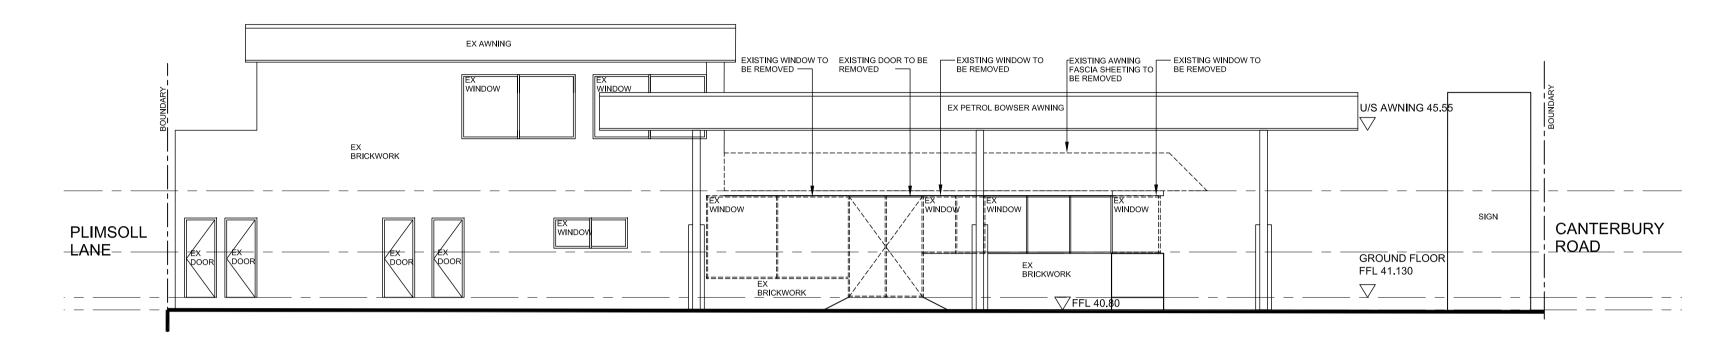

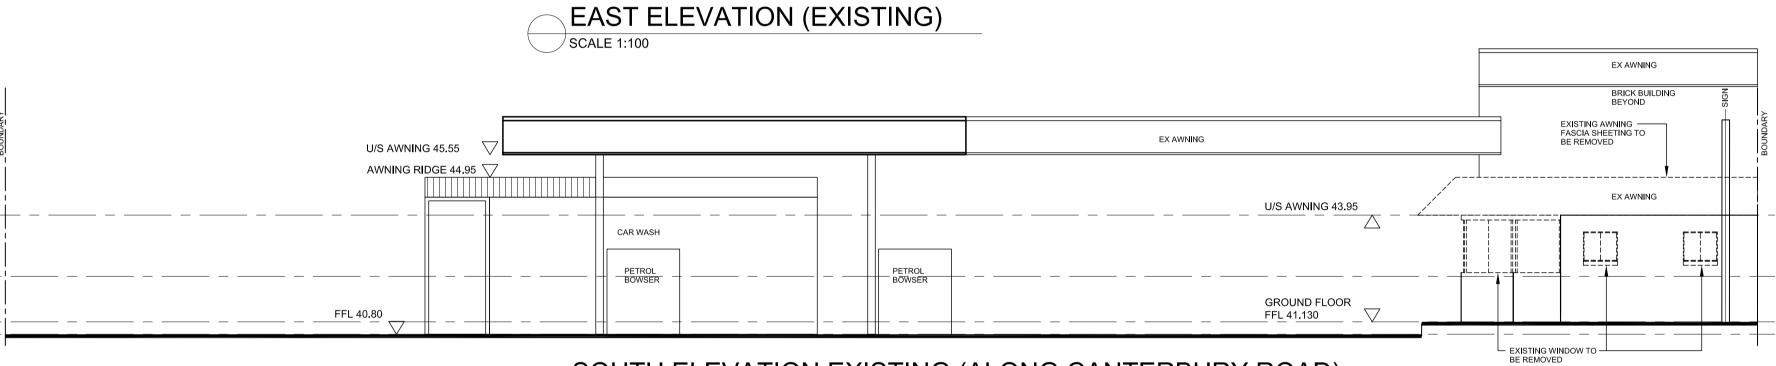


SOUTH ELEVATION EXISTING (ALONG CANTERBURY ROAD)
SCALE 1:100


DATE: 15.02.22

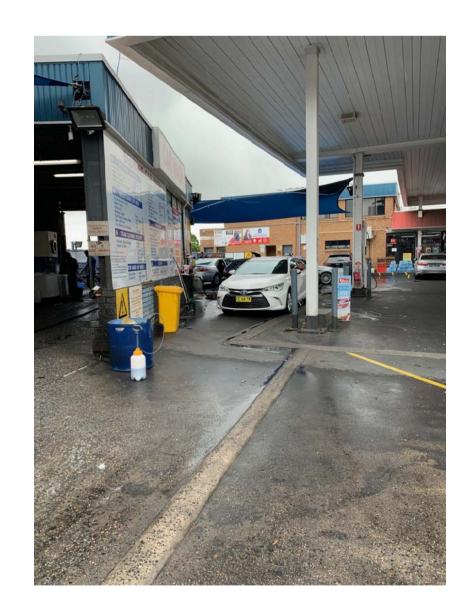


EXISTING BUILDING

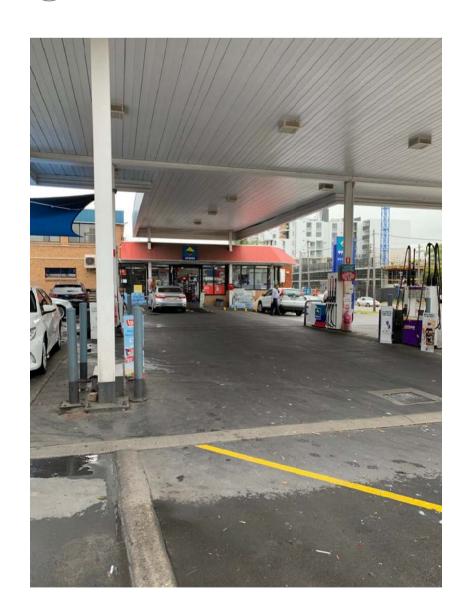

EXISTING BUILDING

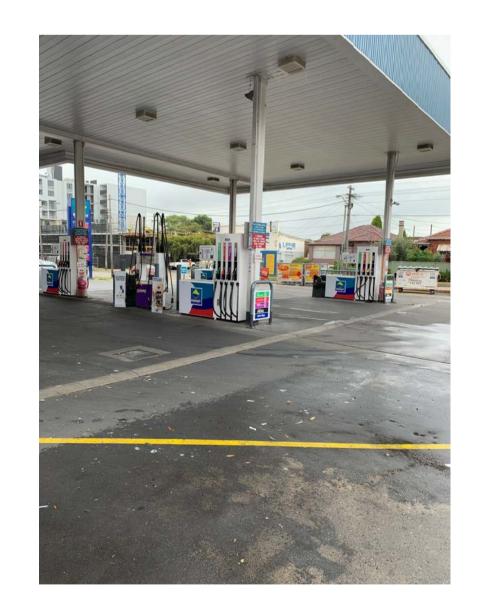

EXISTING BUILDING

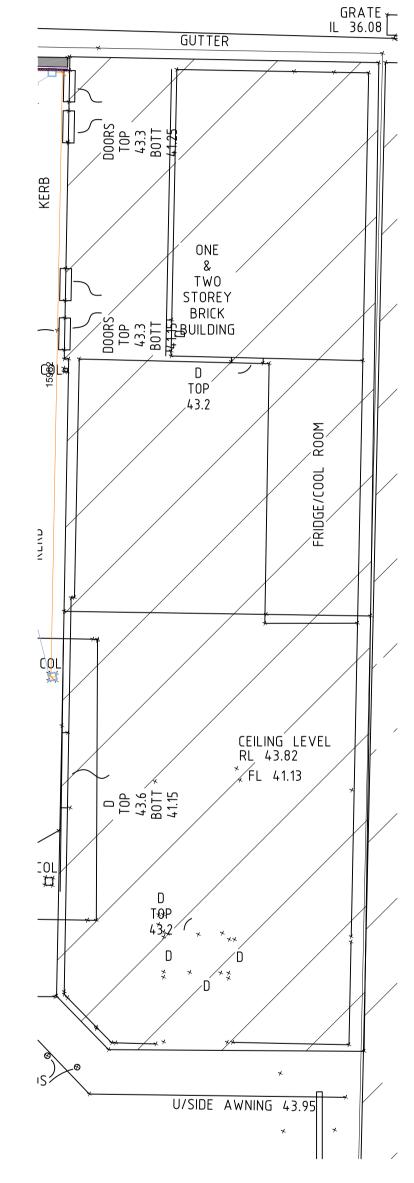

EXISTING / DEMOLITION PLAN SCALE 1:100



Silverwater NSW 2128 PO Box 427, Merrylands NSW 2160

Phone: 02 9648 8848

NOTE: All work to be carried out in accordance with BCA, SAA & Council's conditions.


COPYRIGHT: The concepts & information contained in these drawings are the copyright of Idraft Group Pty Ltd. Use or duplication in part or in full without written permission of Idraft Group Pty Ltd constitutes an infringement of copyright. Do not scale off architectural drawings. These notes must be read in conjunction with colours selection for additional details on appliances, PC architectural drawings. These notes must be read in conjunction with colours selection for additional details on appliances, PC items & shower sizes shown on plan are inside hob dimensions shower screens to be fitted on inside of hob bulkheads may be required to accommodate drainage lines & steel beams position to be determined on site.

USE FIGURED DIMENSIONS ONLY, DO NOT SCALE. Finished ground levels on plans are subject to site conditions, all calculated dimensions are subject to site measure during construction & no allowance has been made for shrinkage or milling position of electrical meter to be determined on site in accordance to the correct position front garden tap on meter.

ENERGY SMART DESIGN: AAA rated water conservation devices include rainwater tanks shower heads, water taps flow regulators, dual flush toilets cisterns & compliant hot water systems with minimum green house score of 3 stars are to be used in this development. Occupants are encouraged to use AAA rated dish washing machines with front loading where possible.

DO NOT SCALE OFF ARCHITECTURAL DRAWINGS SEC4.55 ISSUE



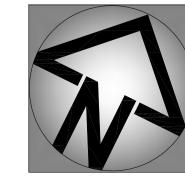



Proposed Manual Car Wash

Drawing Title:
EXISTING FACADE PLAN AND ELEVATIONS
AND LLEVATIONS

Belmore Car Wash Pty Ltd


Local Government Area: Canterbury - Bankstown Council 607 CANTERBURY ROAD, BELMORE <u>Drawing #:</u> Project #: 28657

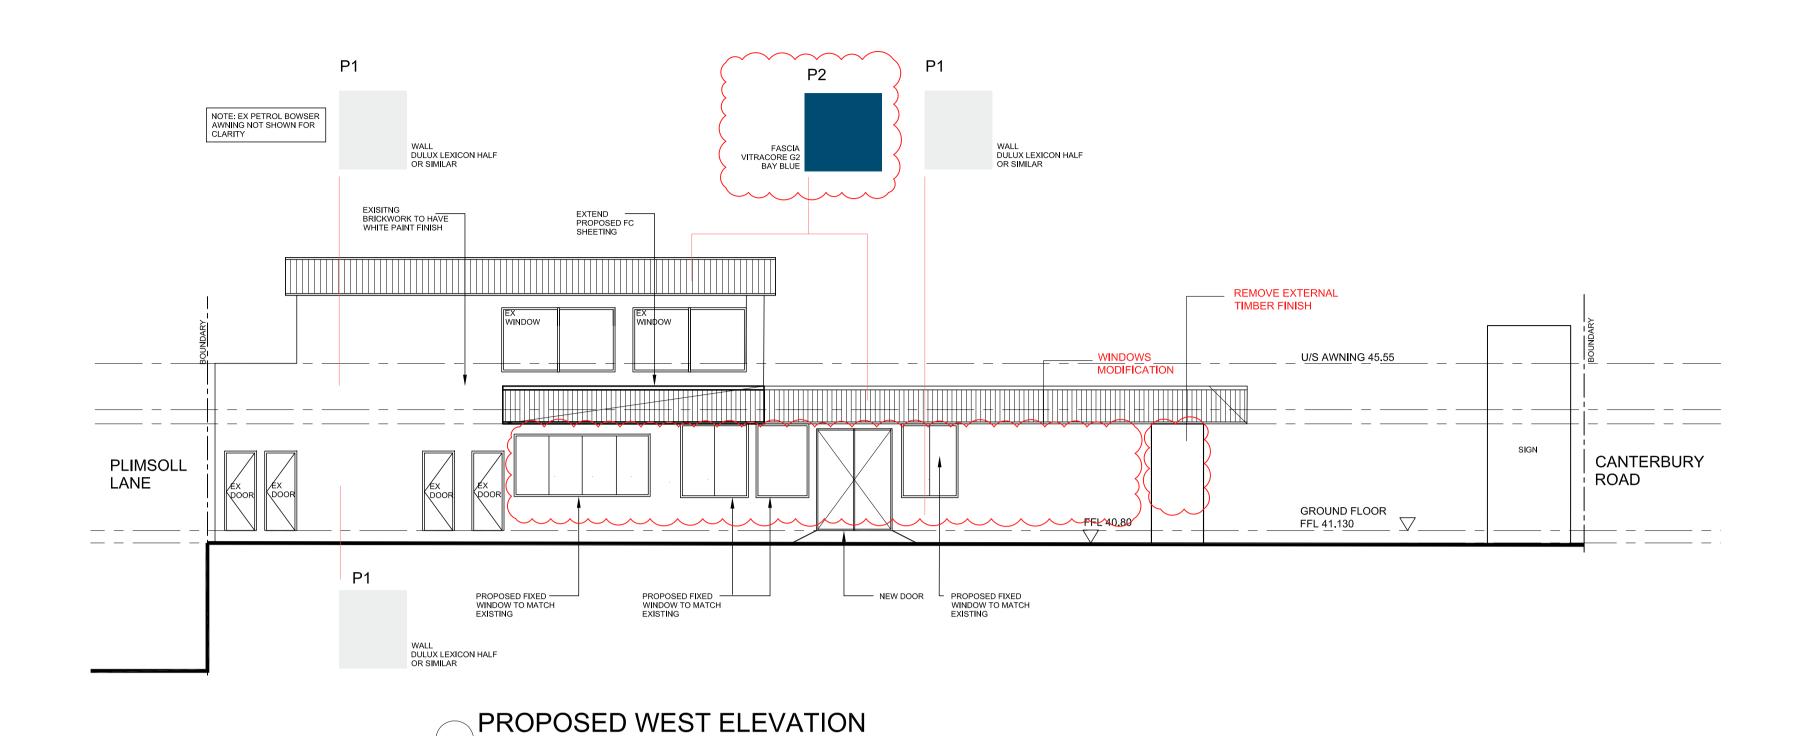

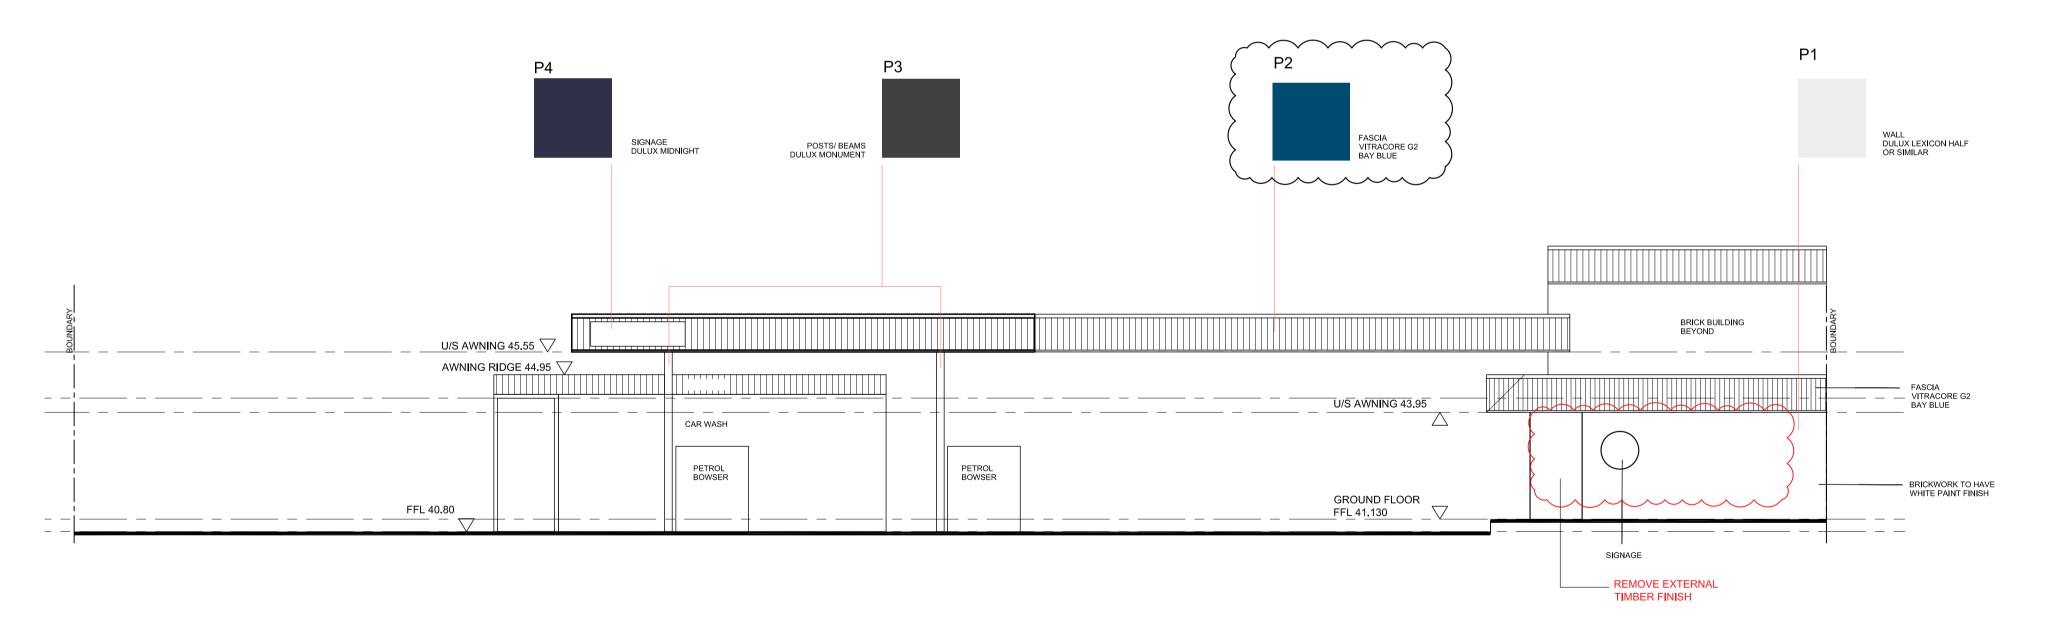

PROPOSED SOUTH ELEVATION

SCALE 1:100

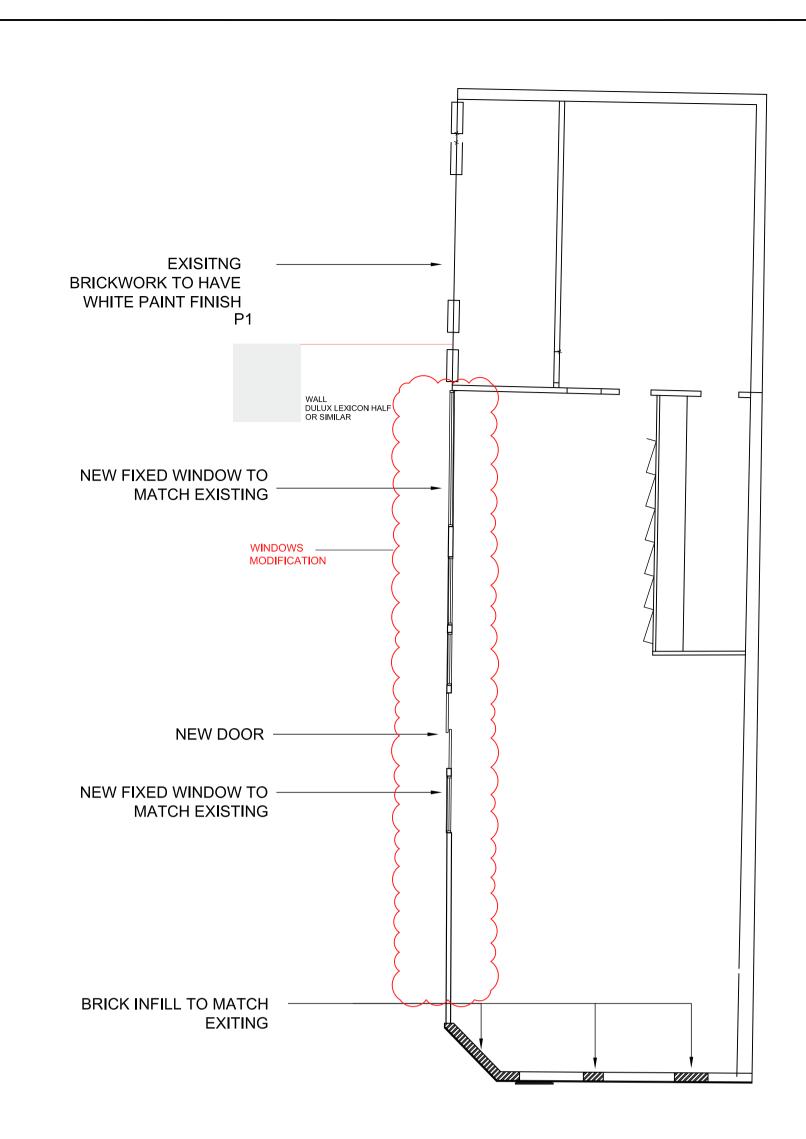








NOTE: All work to be carried out in accordance with BCA, SAA & Council's conditions.

COPYRIGHT: The concepts & information contained in these drawings are the copyright of Idraft Group Pty Ltd. Use or duplication in part or in full without written permission of Idraft Group Pty Ltd constitutes an infringement of copyright. Do not scale off architectural drawings. These notes must be read in conjunction with colours selection for additional details on appliances, PC **AMENDMENTS** DATE: 15.02.22 SEC4.55 ISSUE items & shower sizes shown on plan are inside hob dimensions shower screens to be fitted on inside of hob bulkheads may be required to accommodate drainage lines & steel beams position to be determined on site. USE FIGURED DIMENSIONS ONLY, DO NOT SCALE. Finished ground levels on plans are subject to site conditions, a Silverwater NSW 2128 calculated dimensions are subject to site measure during construction & no allowance has been made for shrinkage or milling PO Box 427, Merrylands position of electrical meter to be determined on site in accordance to the correct position front garden tap on meter.

ENERGY SMART DESIGN: AAA rated water conservation devices include rainwater tanks shower heads, water taps flow NSW 2160 regulators, dual flush toilets cisterns & compliant hot water systems with minimum green house score of 3 stars are to be used in this development. Occupants are encouraged to use AAA rated dish washing machines with front loading where possible.

DO NOT SCALE OFF ARCHITECTURAL DRAWINGS Phone: 02 9648 8848 plans@idraft.com.au www.idraft.com.au



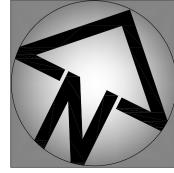


Project Title:
Proposed Manual Car Wash

Drawing Title: PROPOSED FACADE PLAN AND ELEVATIONS

Belmore Car Wash Pty Ltd

	Local Government Area:				
	Canterbury - Bankstown Council				
607 CANTERBURY ROAD, BELMORE	Drawn: JJ / KB	Issue For: SEC4.55	Issue:		
	<u>Date:</u> 15.02.2022	<u>Scale:</u> 1 : 150	Drawing #: A010	Project #: 28657	
		•	•		


APPENDIX 2 Proposed Modified Landscape Plan

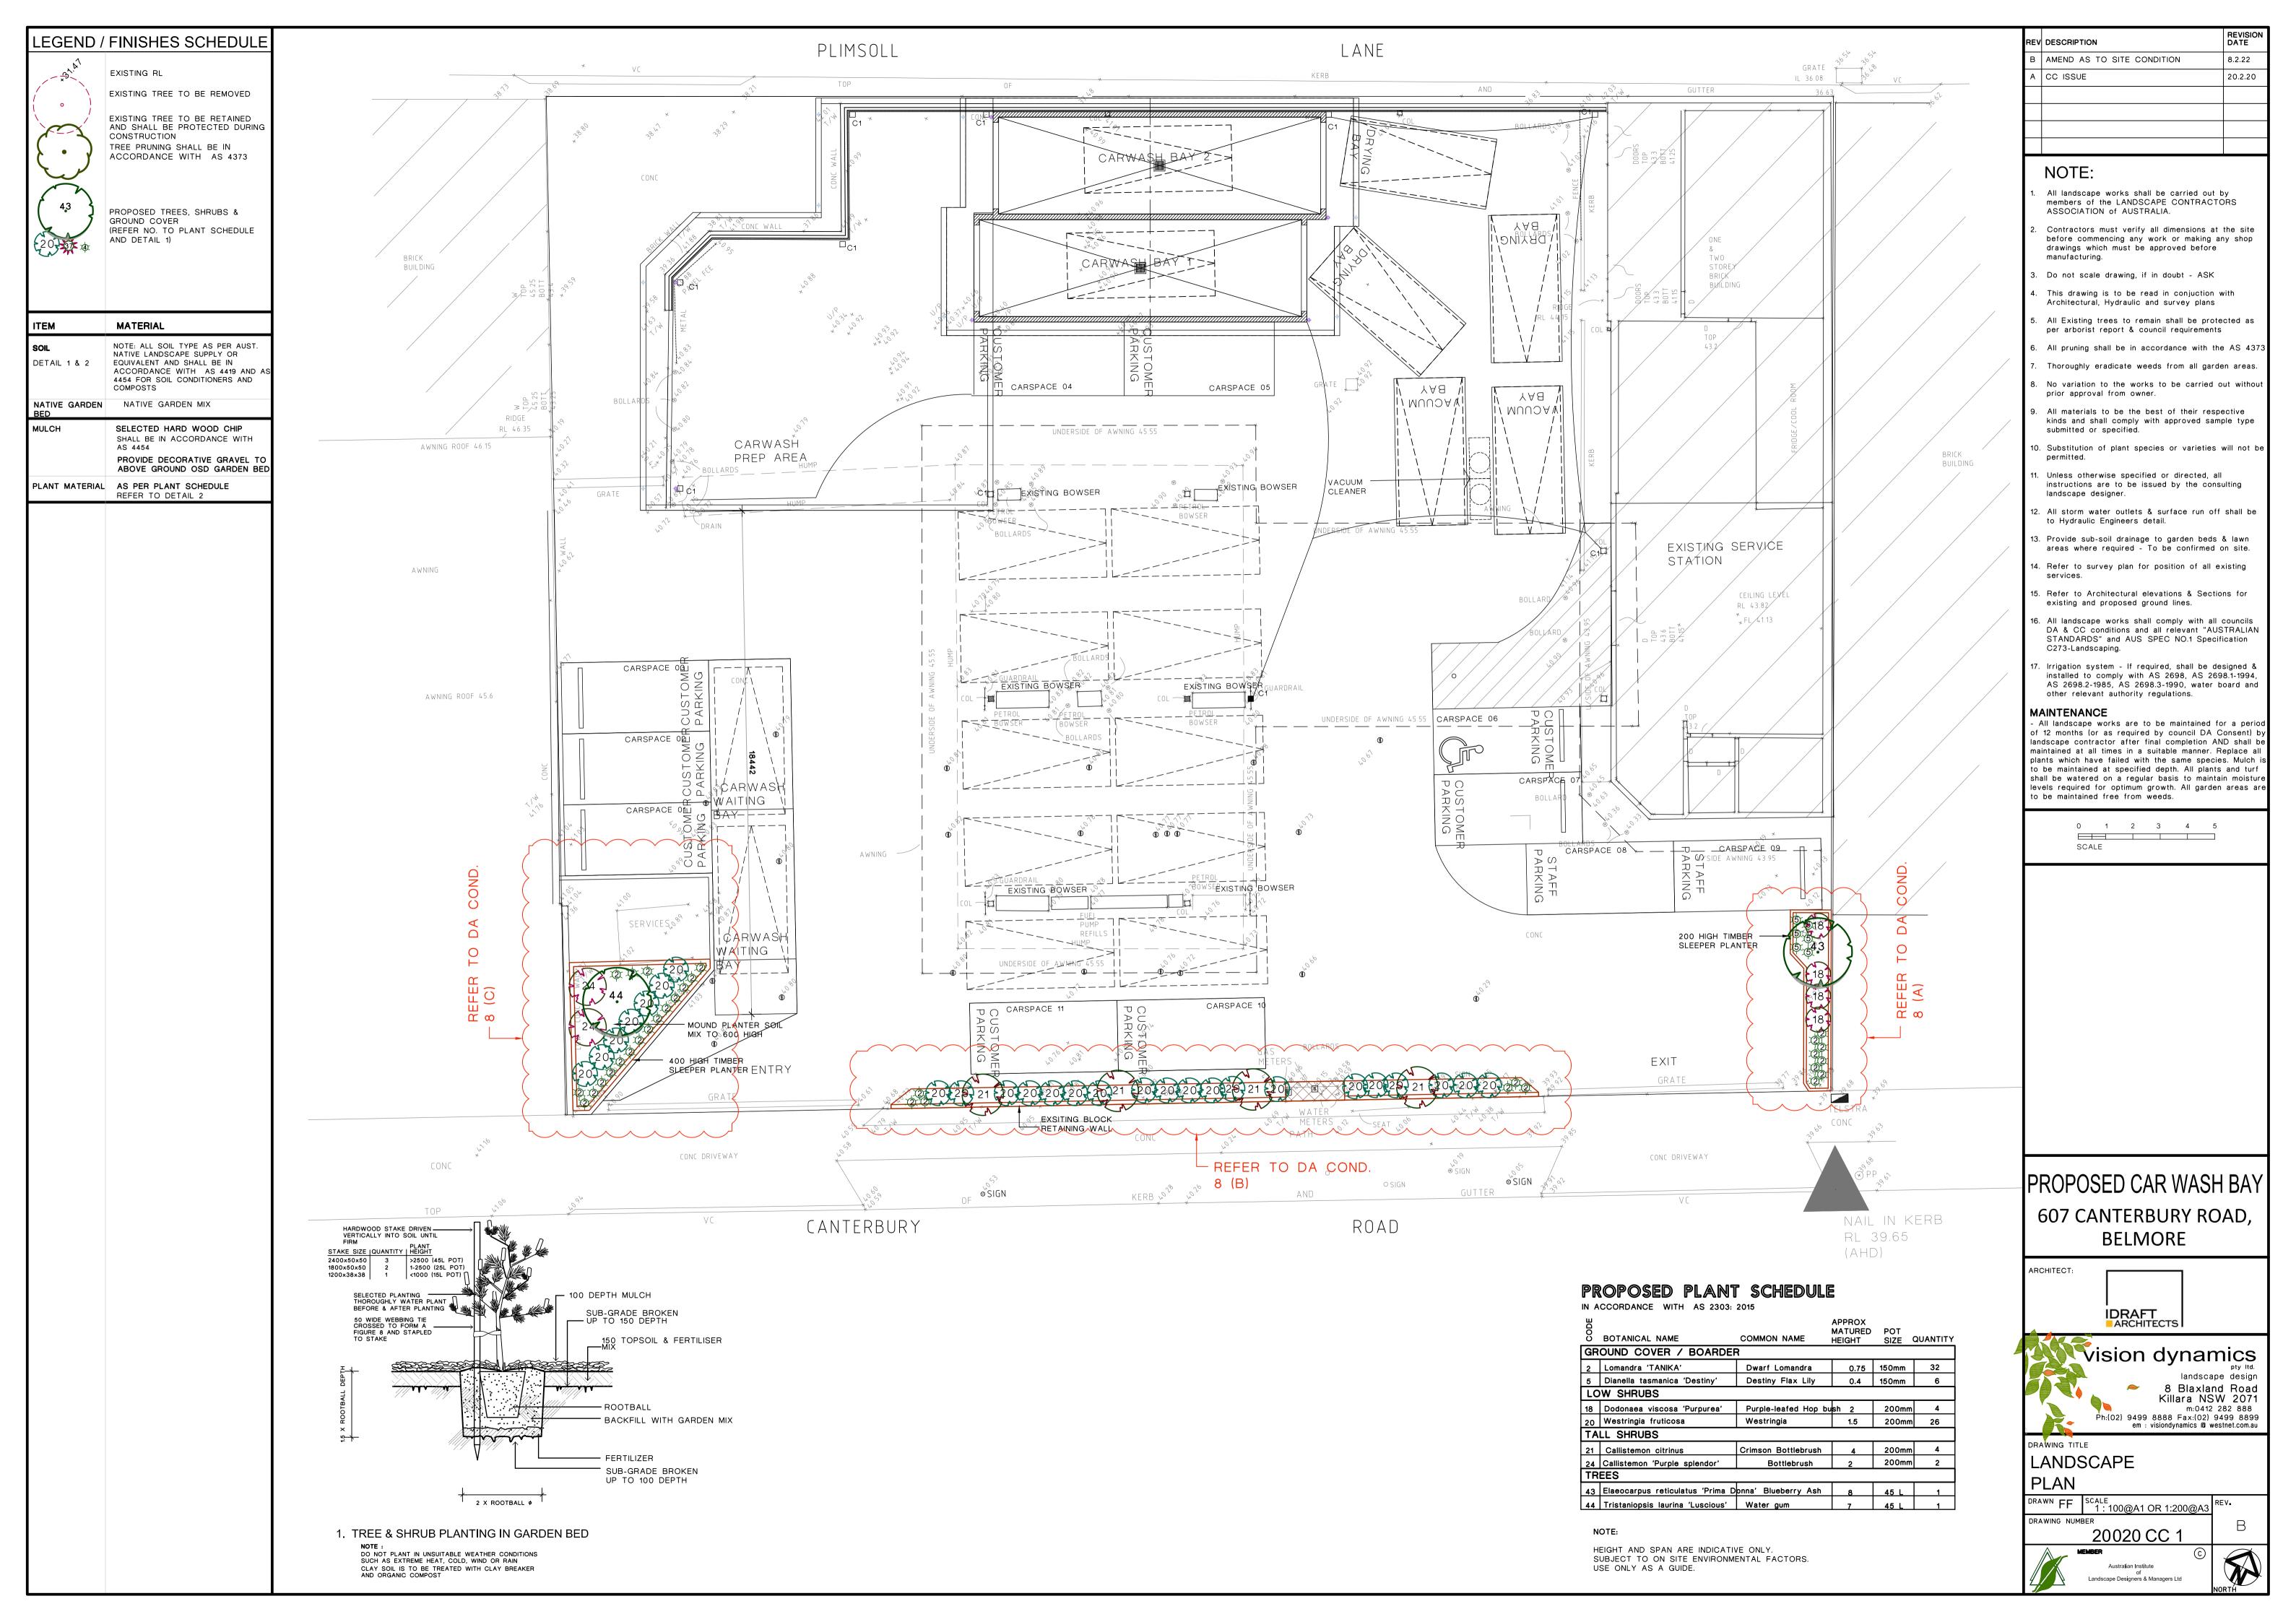

APPENDIX 3 Proposed Modified Stormwater Design

607 CANTERBURY ROAD, BELMORE PROPOSED MANUAL CAR WASH BAYS

STORMWATER CONCEPT PLANS

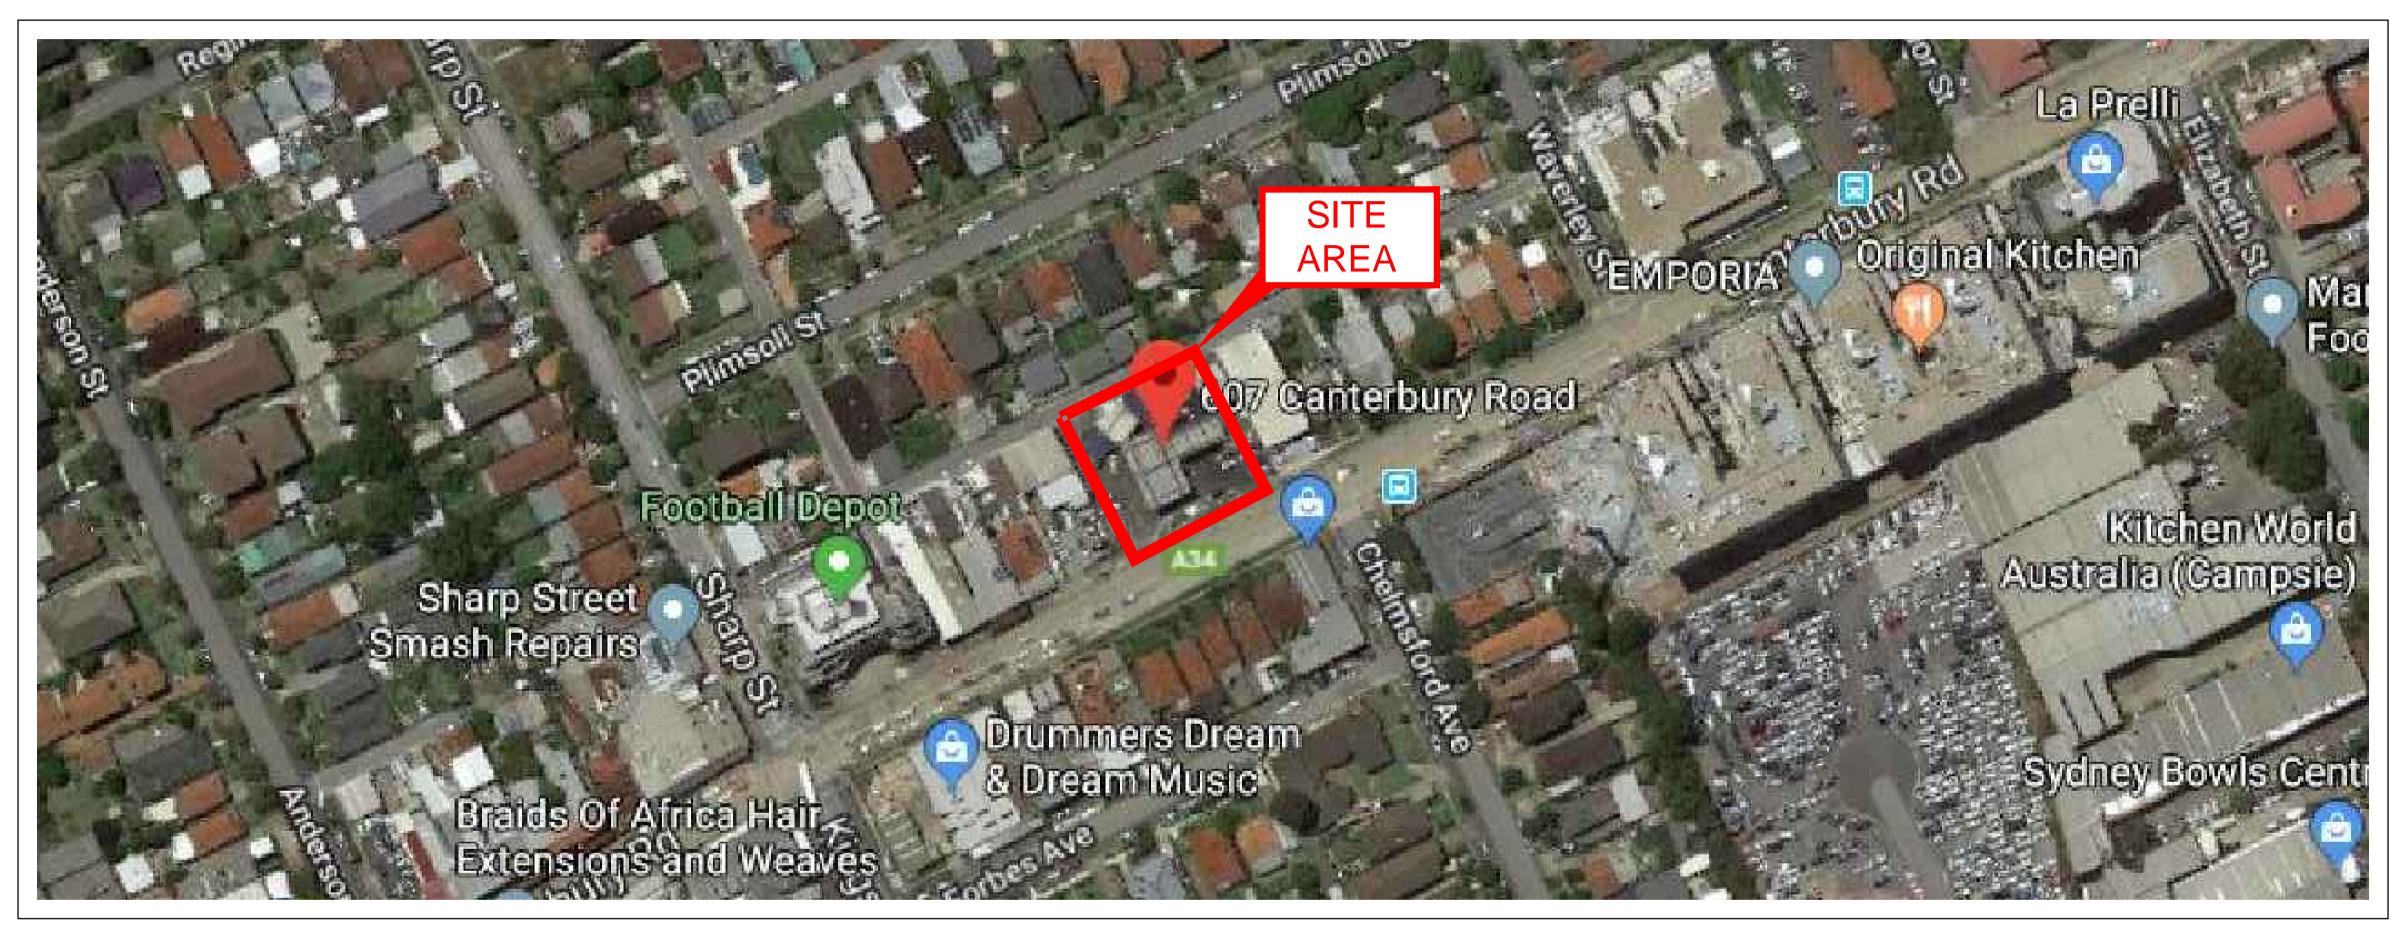

LOCALITY PLAN

DRAWING INDEX			
Drawing No. DESCRIPTION			
000	COVER SHEET PLAN		
101	STORMWATER CONCEPT PLAN		
102	SEDIMENT & EROSION CONTROL PLAN		
103	MISCELLANEOUS DETAILS & CATCHMENT PLAN		

NOT FOR CONSTRUCTION

					Cer in a
					Aus
					-
Α	ISSUE FOR SECTION 4.55	01/03/2022	AGN	JSF	
Issue	Description	Date	Design	Checked	
1cr	m at full size 10cm			20cm	

affiliation with Joe Bacha (formerly

Idraft Architecs Email:pierre@idraft.com.au www.idraft.com.au

Pty Ltd
Unit 43,2 Slough Avenue,
Silverwater NSW 2128


City of Canterbury
Bankstown



607 CANTERBURY ROAD, BELMORE PROPOSED MANUAL CAR WASH BAYS STORMWATER CONCEPT PLANS SECTION 4.55

COVER SHEET PLAN

22120 000

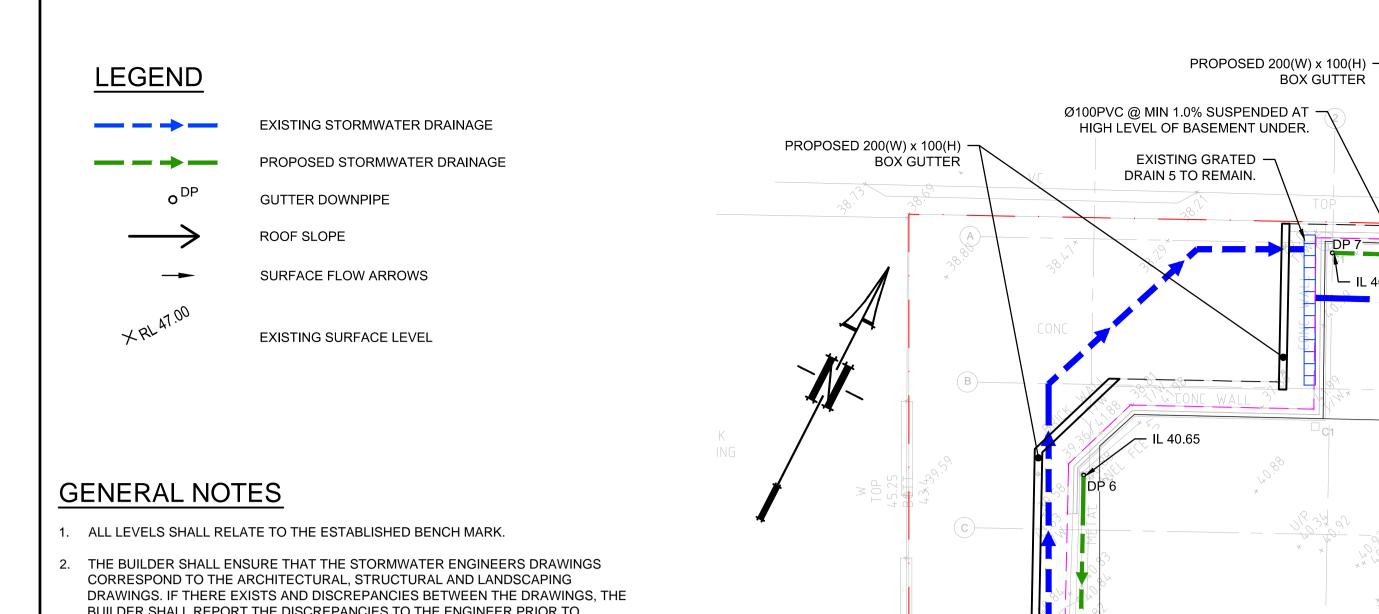

EXISTING STORMWATER PIPE.

SIZE & SLOPE T.B.C.

EXISTING GRATED DRAIN 4 —

TO REMAIN.

DRAINING TO THE ENTRY OF

THE DOWNSTAIRS WORKSHOP,

- BUILDER SHALL REPORT THE DISCREPANCIES TO THE ENGINEER PRIOR TO COMMENCEMENT OF ANY WORKS
- PRIOR TO COMMENCING ANY WORKS, THE BUILDER SHALL ENSURE THAT THE INVERT LEVELS OF WHERE THE SITE STORMWATER SYSTEM CONNECTS INTO THE COUNCILS KERB/DRAINAGE SYSTEM MATCHED THE DESIGN LEVELS. ANY DISCREPANCIES SHALL BE REPORTED TO THE DESIGN ENGINEER IMMEDIATELY.
- 4. ALL LINES ARE TO BE Ø90 uPVC 1.0% GRADE UNLESS NOTED OTHERWISE. CHARGED LINES TO BE SEWERGRADE & SEALED.
- 5. EXISTING SERVICES LOCATIONS SHOWN INDICATIVE ONLY.
- 6. IT IS THE CONTRACTORS RESPONSIBILITY TO LOCATE & LEVEL ALL EXISTING SERVICES PRIOR TO THE COMMENCEMENT OF ANY WORKS.
- 7. ALL EXISTING LEVELS TO BE CONFIRMED BY BUILDER PRIOR TO CONSTRUCTION.
- 8. ALL WORK WITHIN COUNCIL RESERVE TO BE INSPECTED BY COUNCIL PRIOR TO CONSTRUCTION.
- 9. ALL WORK SHALL BE IN ACCORDANCE WITH B.C.A. AND A.S.3500.3.

ENSURE EXISTING RLs ARE RETAINED

Ø65 PVC @ MIN 1.0% Ø90 PVC @ MIN 1.0% Ø100 PVC @ MIN 1.0% Ø150 PVC @ MIN 1.0% Ø225 PVC @ MIN 0.5% Ø300 PVC @ MIN 0.4%

GROUND FLOOR PLAN SCALE 1:100

EXISTING GRATED BOX DRAIN

CONNECTED TO PIT 6 IN

DOWNSTAIRS OFFICE.

SIZE & SLOPE T.B.C.

FFL 41.00

ROOF ABOVE OUTLINE

− IL 40.60 🖯

EXISTING OUTLETS -TO WASTE WATER

DRAINAGE SYSTEM

CARWASH

PREP AREA

WAITING BAY

CARWASH WAITING BAY

EXISTING GRATED -

ENTRY

DRAIN 8 TO REMAIN.

LANDSCAPE (DEEP SOIL) RL +40.92 (COS) $^{igstyle igstyle igytyle igstyle igstyle igytyle igstyle igytyle igytyle$

HIGH LEVEL OF BASEMENT UNDER.

BASEMENT BELOW OUTLINE

CARSPACE 04

EXISTING PIT 6 IN OFFICE -

FLOOR), TO REMAIN.

BOX GUTTER

DETAILS T.B.C.

PROPOSED 200(W) x 100(H)

YA8

VACUUM

DOWNSTAIRS (LID AT OFFICE

YAB

MUUDAV

EXISTING Ø150mm uPVC PIPES

UNDERSIDE OF AWNING GARSPACE 06

HINGED UNDER BOTTOM OF

CEILING, TO REMAIN.

— Ø150PVC @ MIN 1.0%

IL 40.47 -

DP 3

IL 40.38 —

EXISTING PIT 2 —

TO REMAIN

CARSPACE 05

EXISTING BOWSER GUARDRAL

CARSPACE 10

OF BASEMENT UNDER.

SUSPENDED AT HIGH LEVEL

EXISTING PIT 7 IN LANEWAY. —

CNXT 2 -

CNXT 3

SIZE & SLOPE T.B.C.

IF IT'S LESS THAN Ø225

EXISTING STORMWATER PIPE.

PIPE SIZE TO BE UPGRADED TO Ø225

EXISTING PIPE DRAINING TO -

PIPE SIZE & SLOPE T.B.C.

OUTLINE OF

WORKSHOP

DOWNSTAIRS

OFFICE

EXISTING STATION

EXISTING 200x100 -**GALVANISED BOX**

SECTION TO REMIAN

DP 2

EXISTING GRATED -

DRAIN 3 TO REMAIN.

CARSPACE-07

LANEWAY, TO REMAIN

NAIL IN KERB

NOT FOR CONSTRUCTION Idraft Architecs
Pty Ltd
Unit 43,2 Slough Avenue,
Silverwater NSW 2128
BLONE: 02 9648 8848


City of Canterbury
BLONE: 02 9648 8848 in affiliation with Joe Bacha (formerly Australian Consulting Engineers): 607 CANTERBURY ROAD, BELMORE STORMWATER CONCEPT PLAN PROPOSED MANUAL CAR WASH BAYS STORMWATER CONCEPT PLANS SCALE 1:100 @ A1 ISSUE FOR SECTION 4.55 01/03/2022 | AGN | JSF Email: info@telfordcivil.com.au Level 4, 470 Church Street, PHONE: 02 9648 8848 Parramatta NSW 2150 SECTION 4.55 Phone: 02 7809 4931 Design Checked Scale 1:100 Email:pierre@idraft.com.au 22120 101 PO BOX 3579 Parramatta 2124 www.idraft.com.au Company: Telford Consulting Pty Ltd


NOTE: REFER HYDRAULIC ENGINEER'S DETAILS FOR PROPOSED WASTE WATER DRAINAGE WORKS


NOTE: PROPOSED WORKS TO

PIPES NOTE:

UNLESS NOTED OTHERWISE

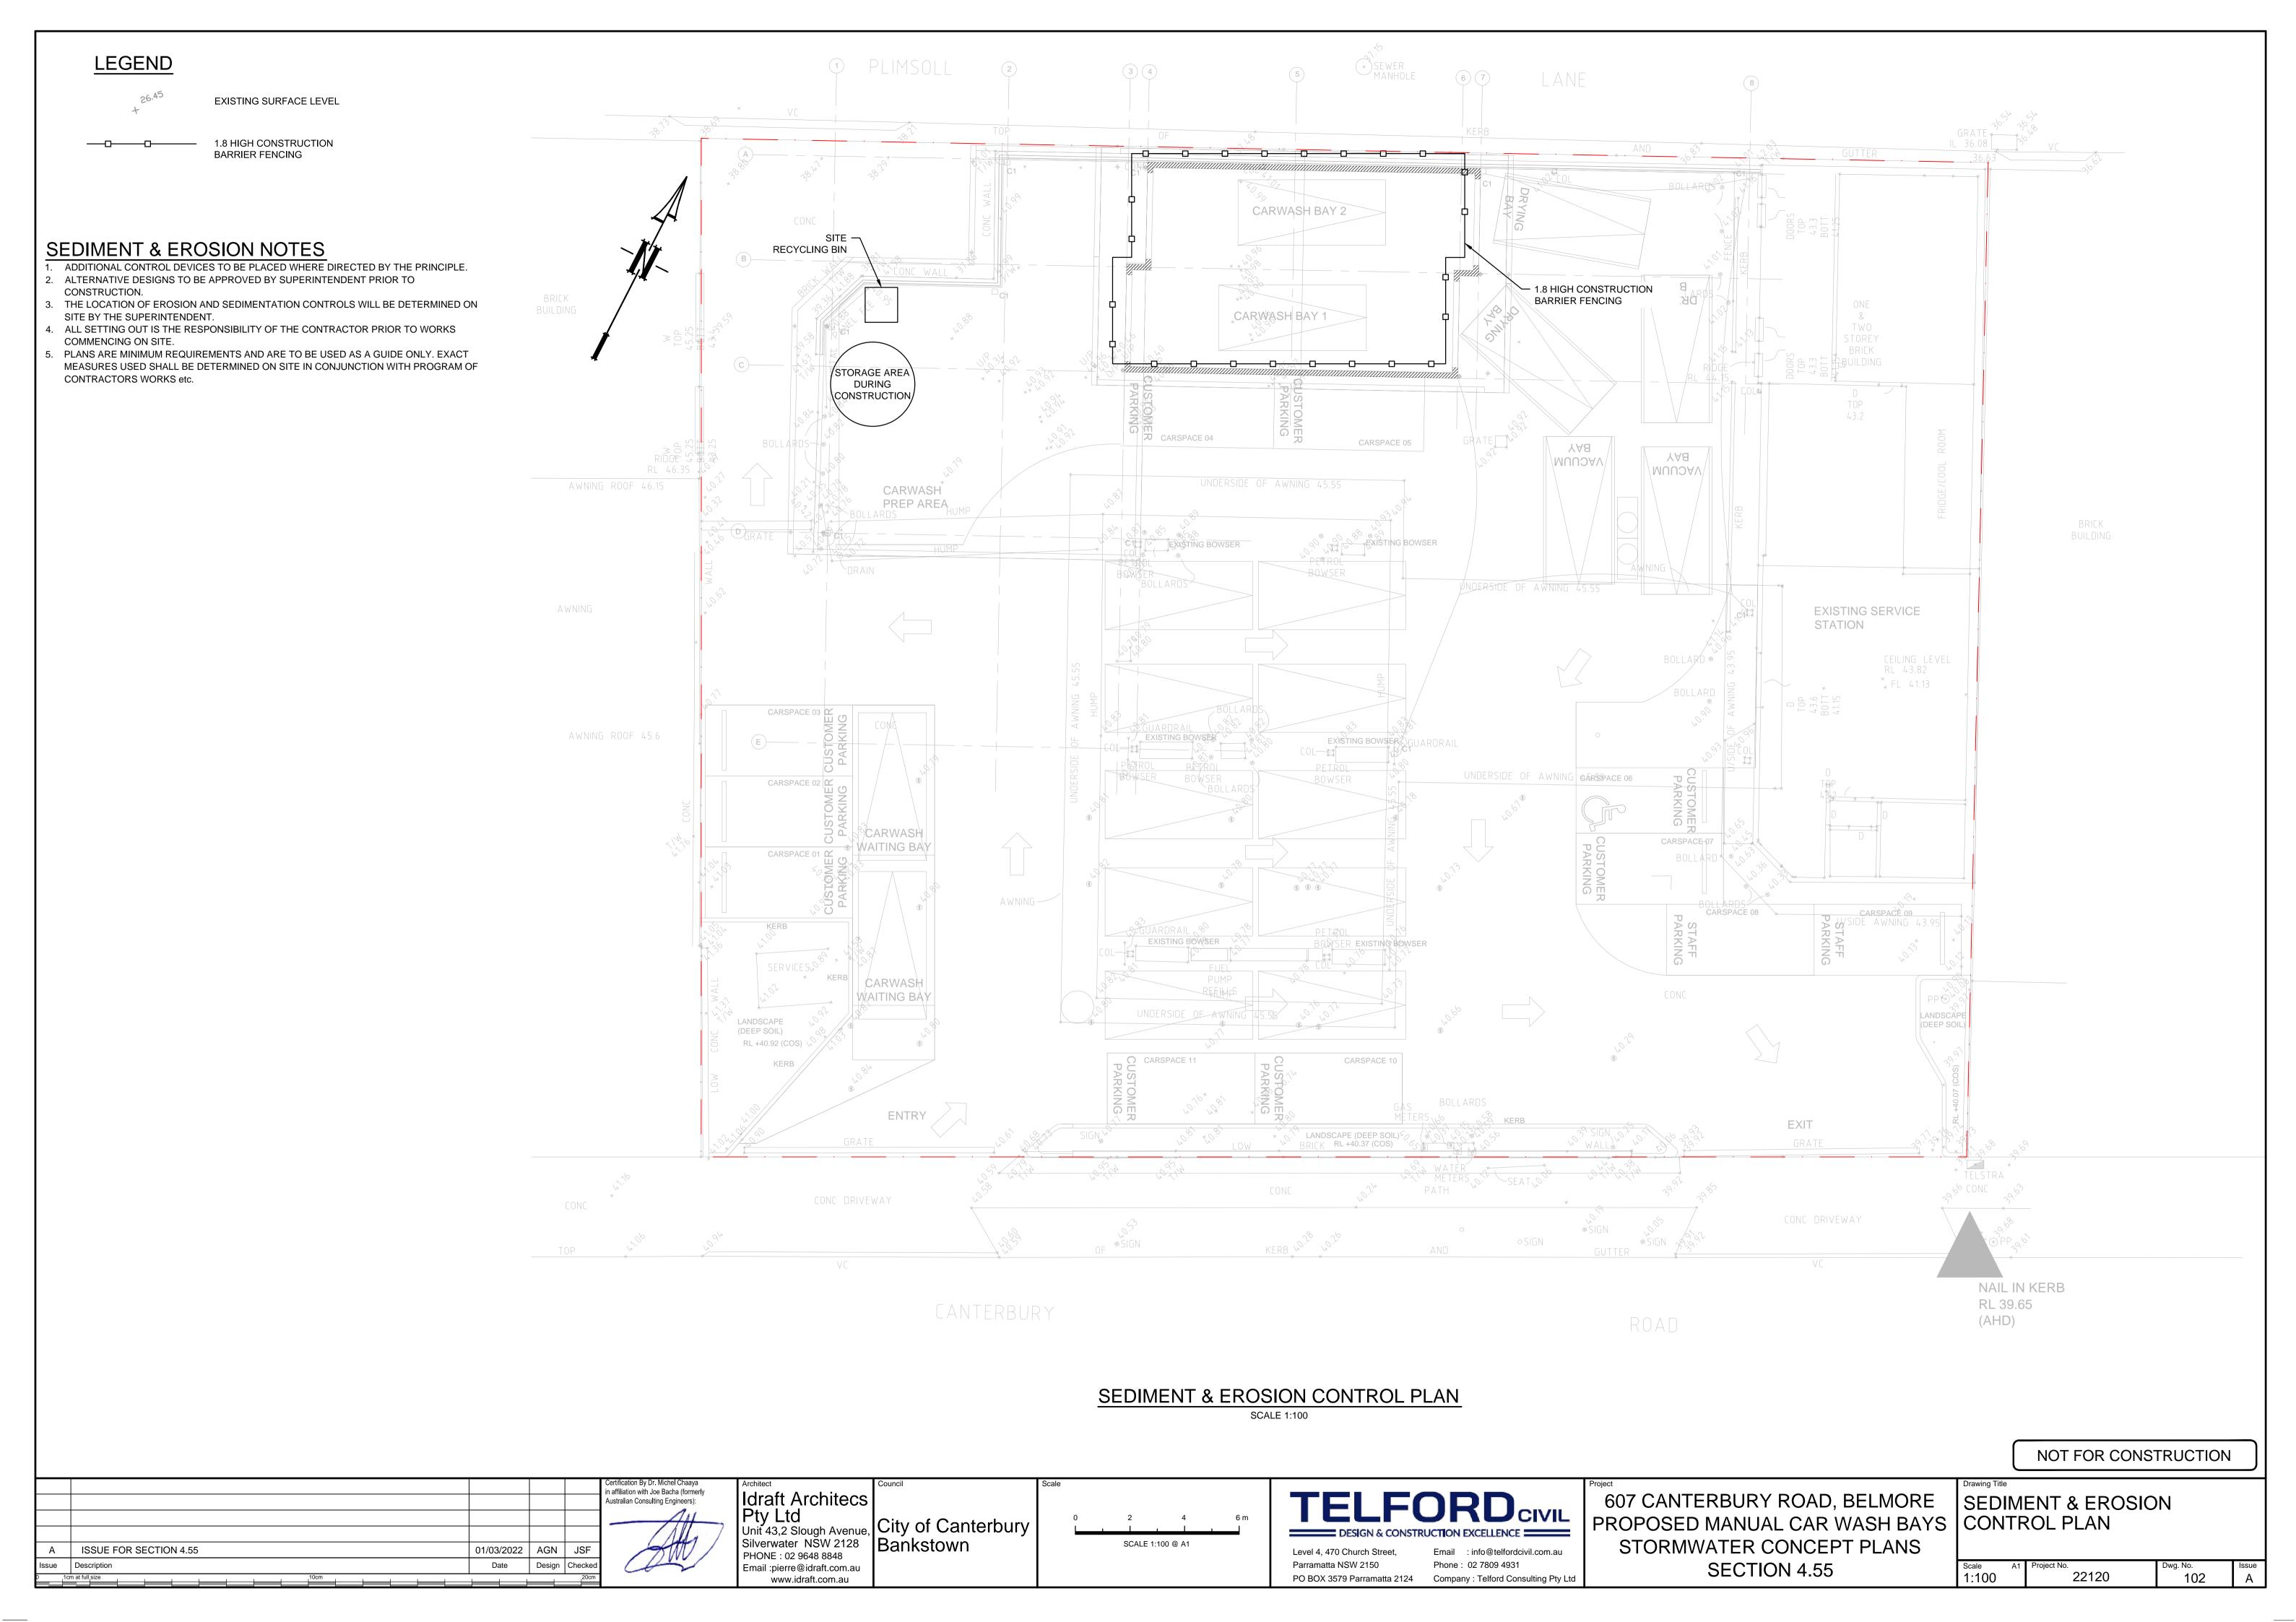

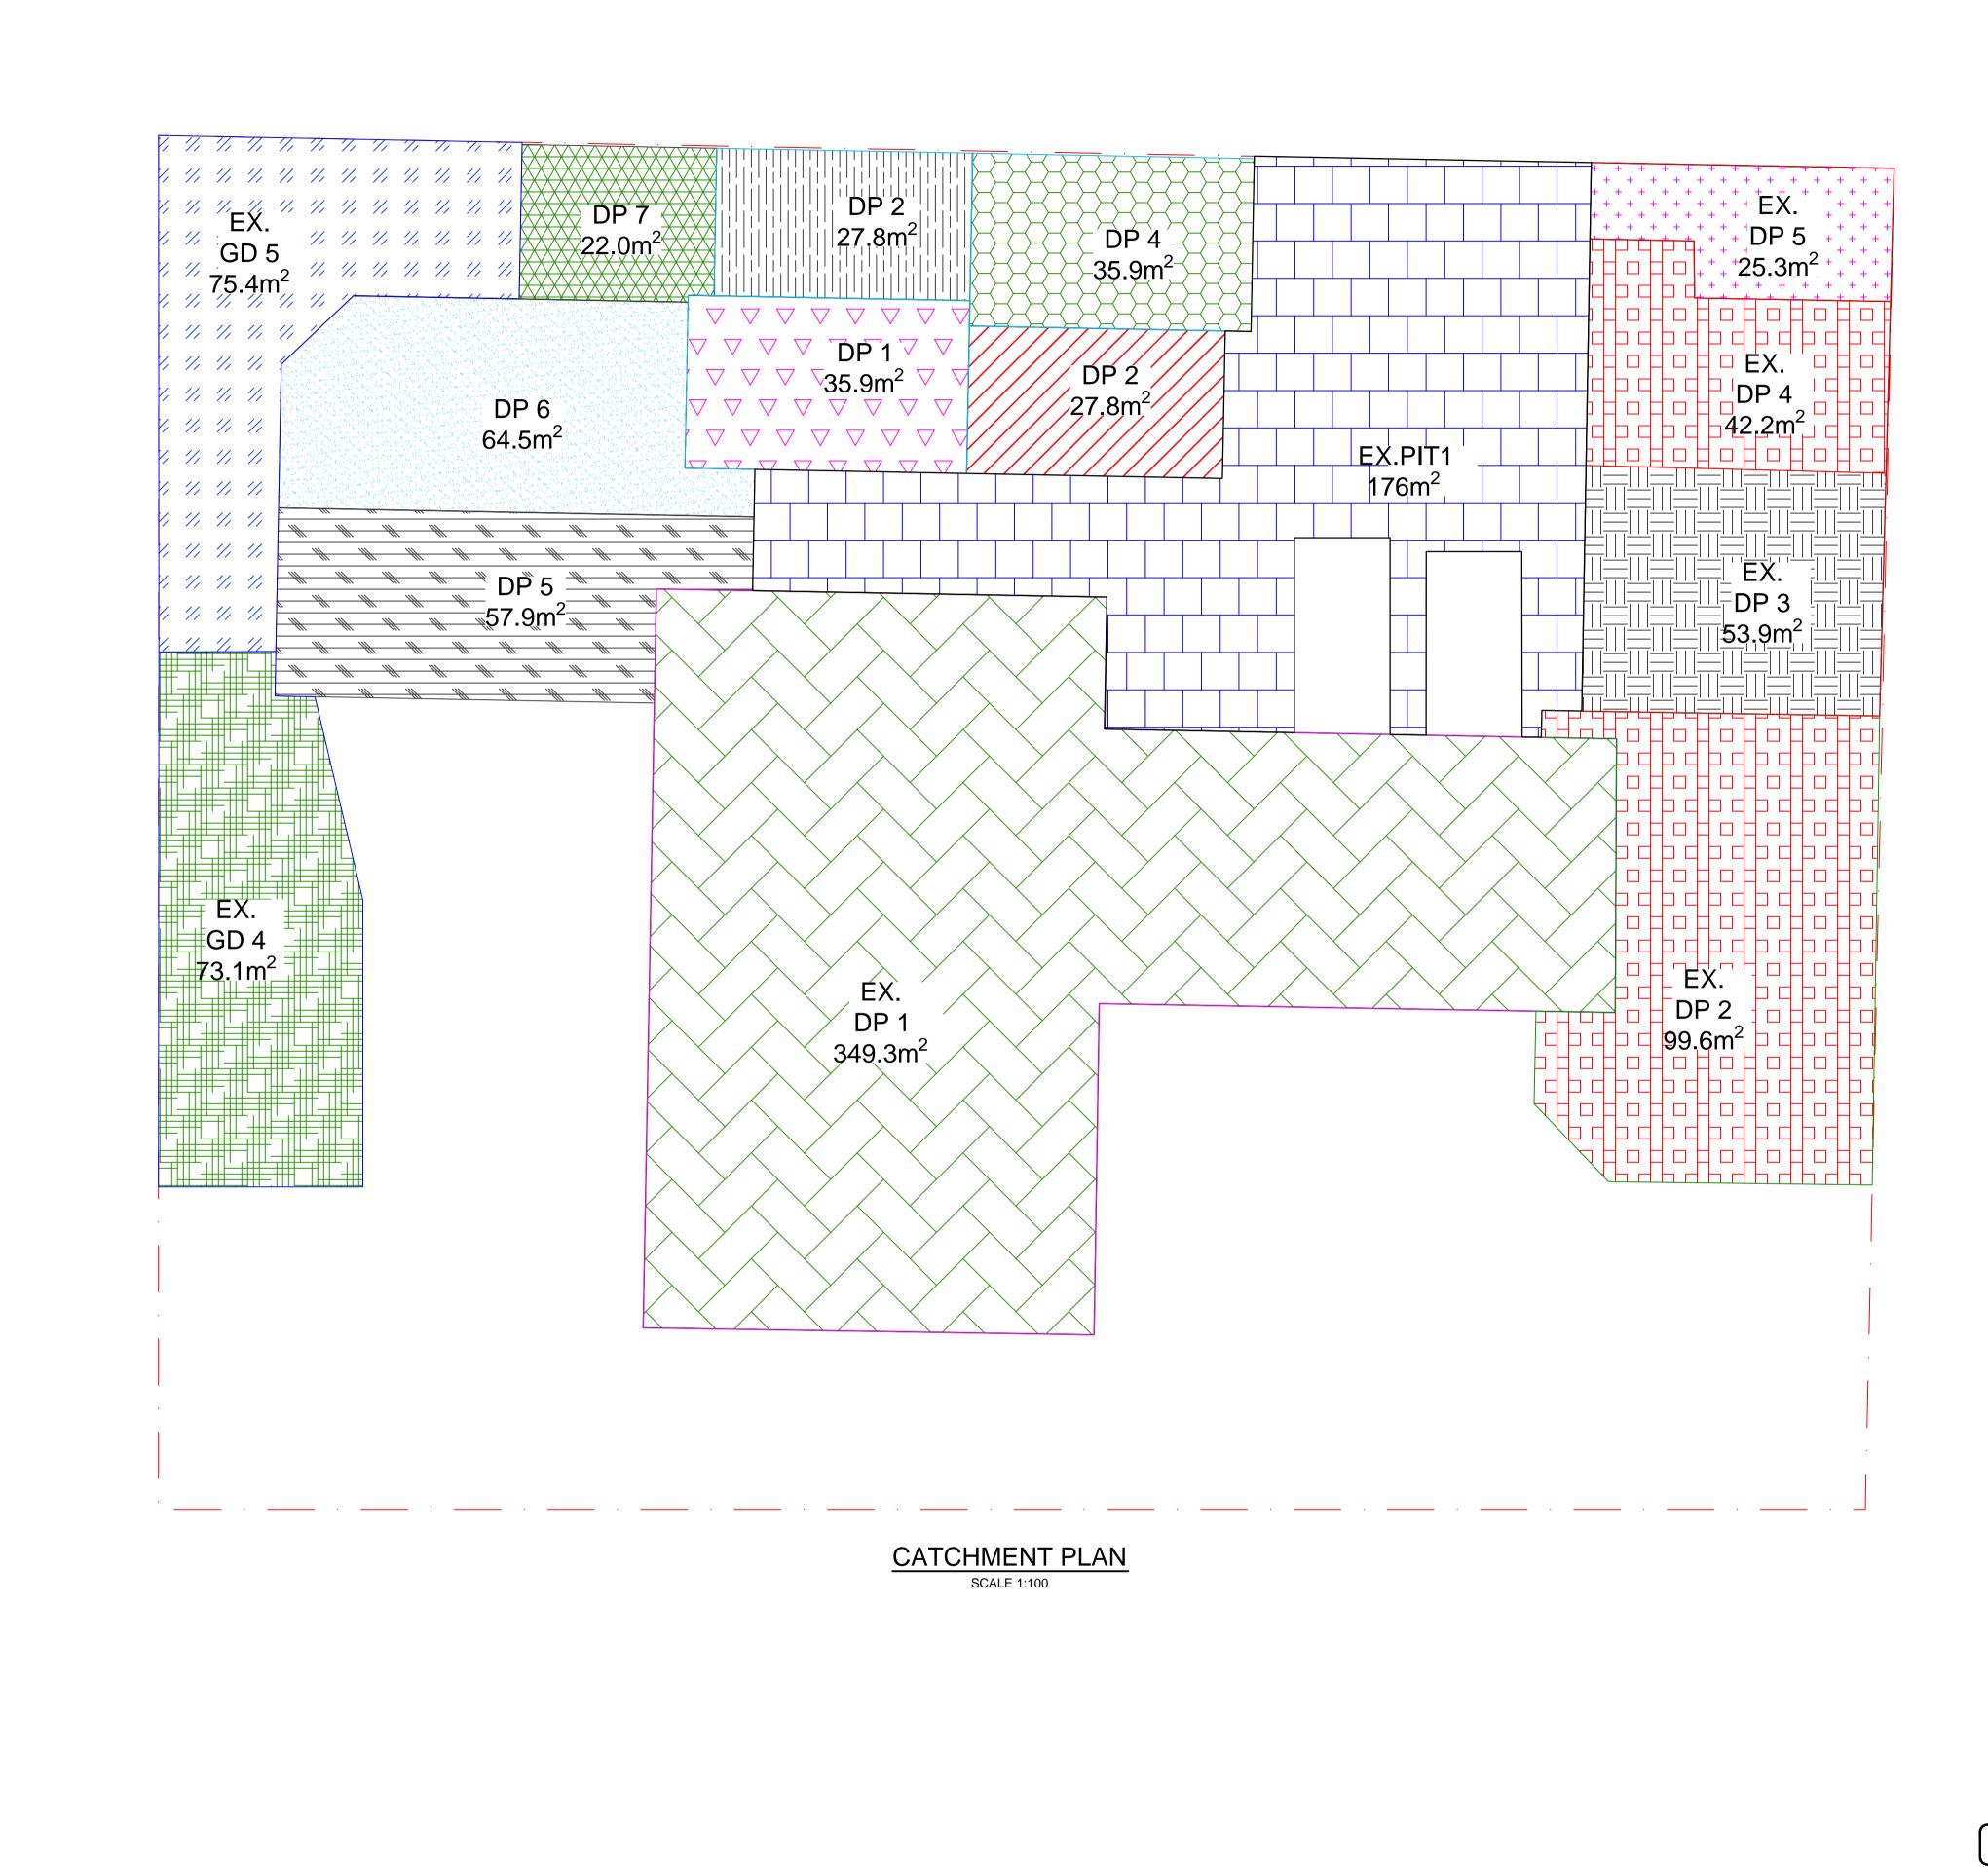

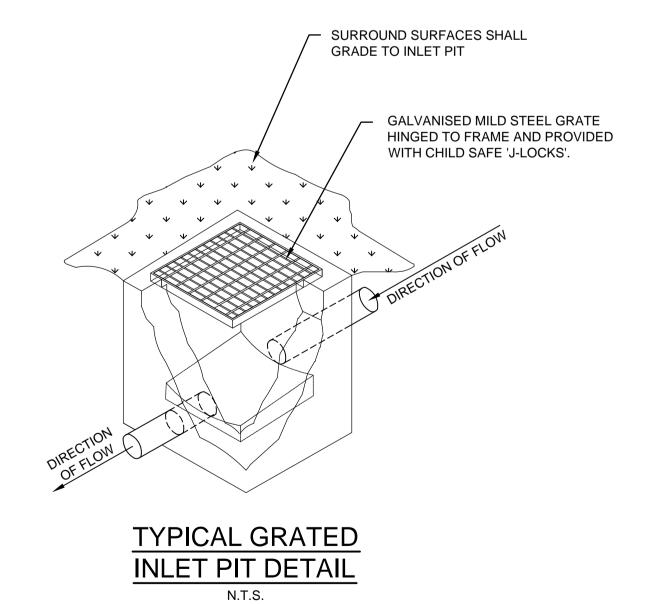

ISSUE FOR SECTION 4.55 01/03/2022 AGN JSF Design Checked

in affiliation with Joe Bacha (formerly Australian Consulting Engineers):

PHONE: 02 9648 8848 Email:pierre@idraft.com.au . www.idraft.com.au

Idraft Architecs
Pty Ltd
Unit 43,2 Slough Avenue,
Silverwater NSW 2128
BHONE: 02 9648 8848

City of Canterbury
BHONE: 02 9648 8848

SCALE 1:100 @ A1

Level 4, 470 Church Street, Email: info@telfordcivil.com.au Parramatta NSW 2150 Phone: 02 7809 4931 PO BOX 3579 Parramatta 2124 Company : Telford Consulting Pty Ltd

607 CANTERBURY ROAD, BELMORE PROPOSED MANUAL CAR WASH BAYS & CATCHMENT PLAN STORMWATER CONCEPT PLANS SECTION 4.55

MISCELLANEOUS DETAILS

Dwg. No. 103 22120

NOT FOR CONSTRUCTION

APPENDIX 4 Fire Safety Compliance



DESIGN CERTIFICATE

Date: 16/10/2020

Hydraulic and Fire Services

Project Name: 607 Canterbury Road, Belmore

Project Number: 191275

We confirm that the design of the hydraulic and fire services for the proposed development at 607 Canterbury Road, Belmore was carried out by this firm.

We certify that the design substantially complies with:

- NCC National Construction Code 2019, (Plumbing Code of Australia) and AS 3500 2018 (Plumbing and Drainage Code);
- NCC National Construction Code 2019, Clause E1.3 (Fire Hydrant Installations) and AS 2419.1 2005 (Fire Hydrant Installations);
- NCC National Construction Code 2019, Clause E1.4 (Fire Hose Reels) and AS 2441 2005 Installation of Fire Hose Reels:

This certificate shall not be construed as relieving any other party of their legal responsibilities or contractual obligations.

Name of Certifier: Anthony Hasham (Director)

Signature:

BEng, MEng, MBA, Ph.D., FIE (AUST), CPEng, NER, RPEQ

Accredited Certifier - C14 & C16, Accreditation No: BPB0173

ACE712 REV1

